


設 計 図

平 面 図
S=1:500

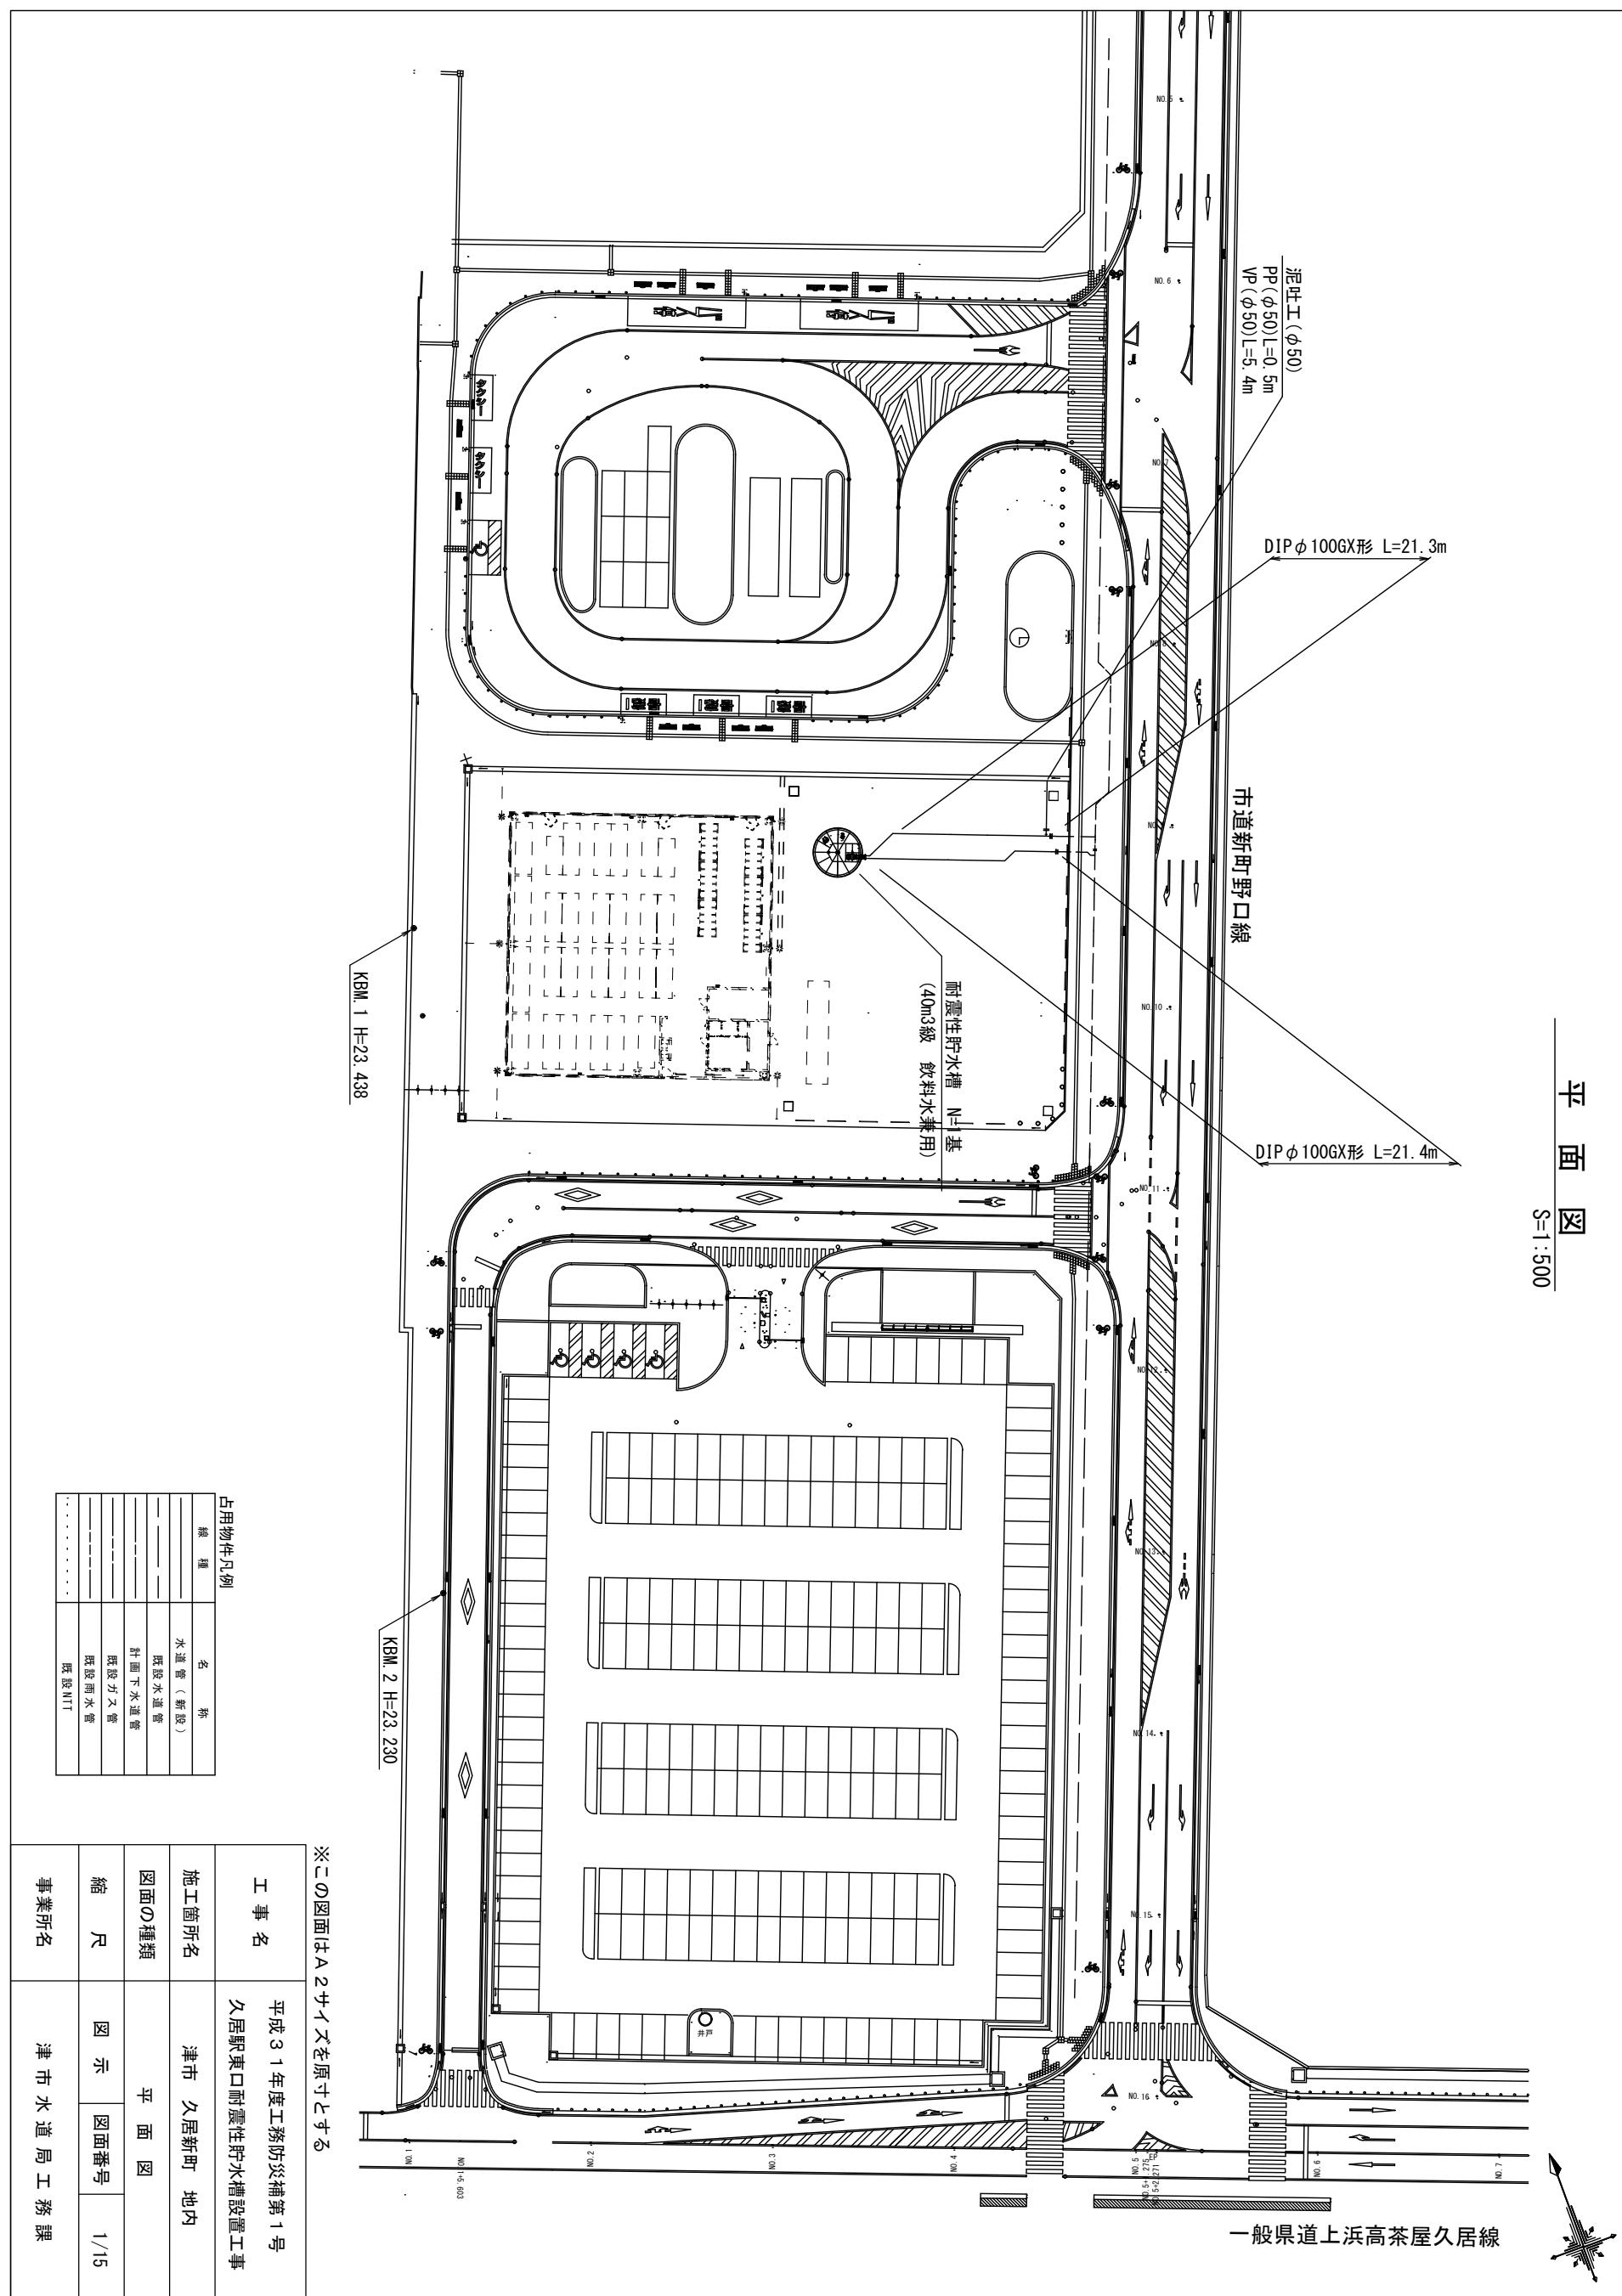


耐震性貯水槽 一般図


S=1:40

自給式ポンプ
給水栓及びスタンド


○ A ~ ○ A 断面図

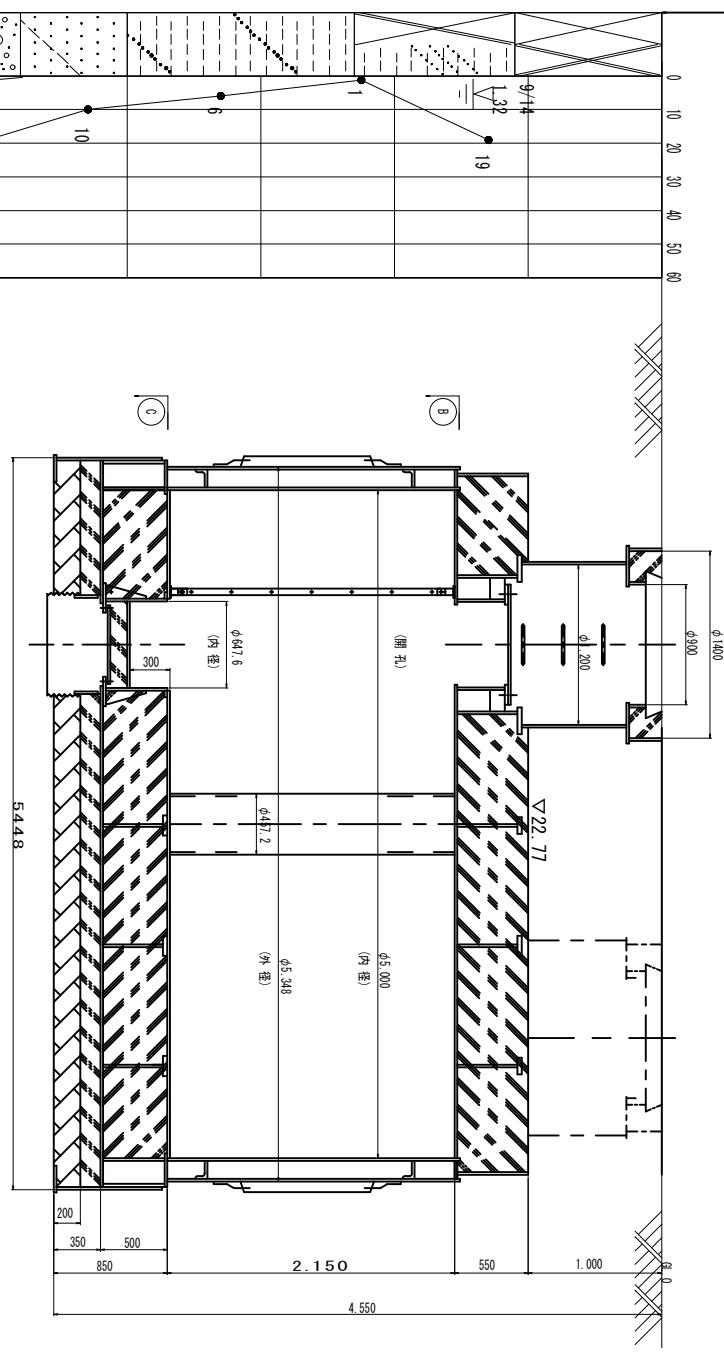

○ B 断面

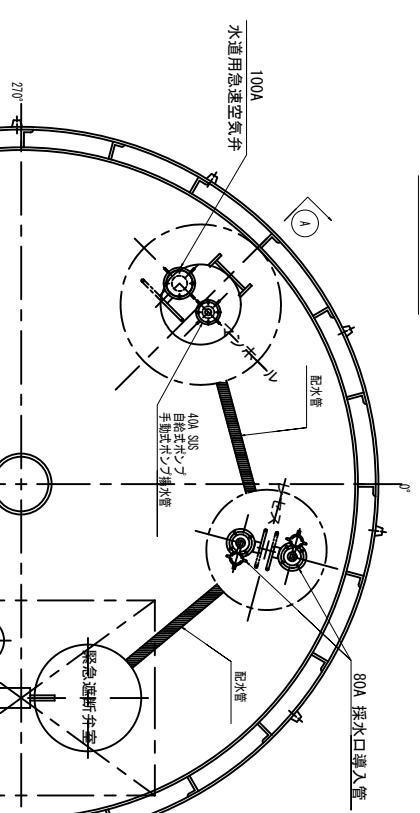

○ C 断面

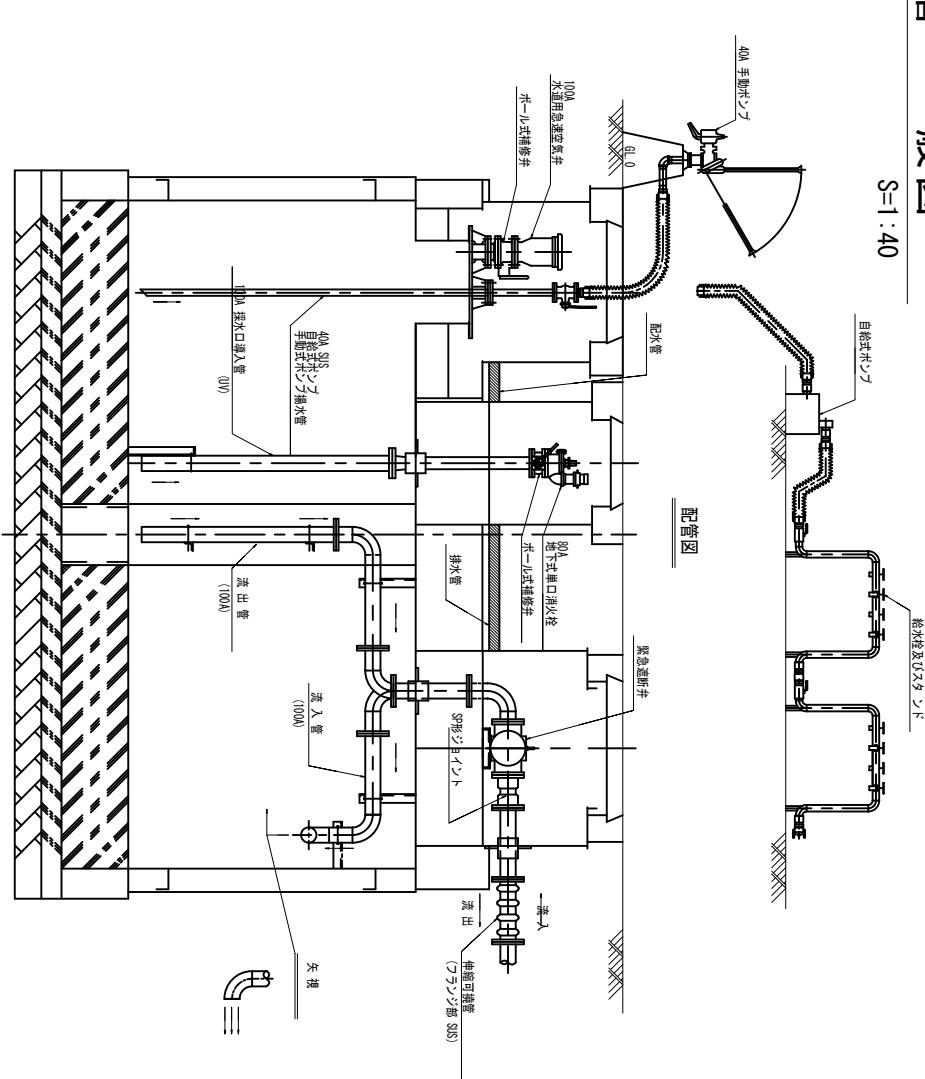

【参考図】
※この図面はA2サイズを原寸とする

日本消防設備安全センター認定二次製品
飲料水兼用耐震性貯水槽 40m³級 III型
(鋼製縦円筒セグメント型 K40-III-7.5同等品)

容 積 表		容積(m ³) ²
項 目	サイ ズ(径 × 高 さ)	
セグメント	φ 5000 × 2144	42.10
支 柱	φ 457.2 × 2144	△ 0.35
容 積合 計		41.75m ³
実 容 積		40.9m ³

工事名	平成31年度工務防災補第1号 久居駅東口耐震性貯水槽設置工事		
施工箇所名	津市 久居新町 地内		
図面の種類	耐震性貯水槽 一般図		
縮尺	図示	図面番号	2/15
事業所名	津市水道局工務課		




耐震性貯水槽 組立施工図(1)

S=1 : 50

斷面圖

4 5 6 底版組立平面図



8 上部セグメント組立平面図

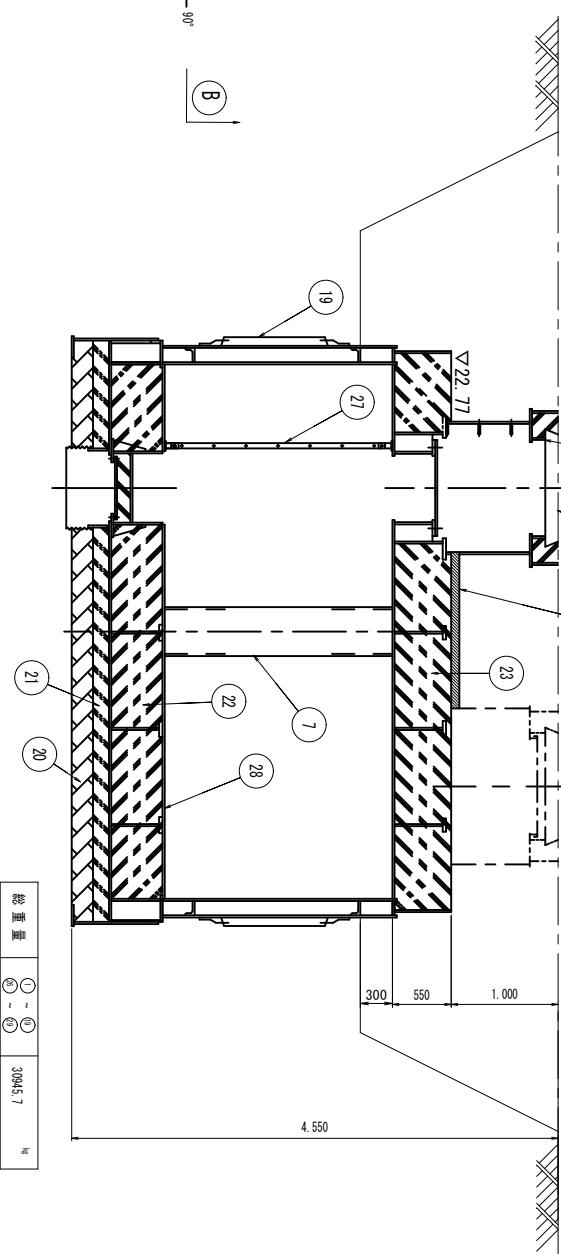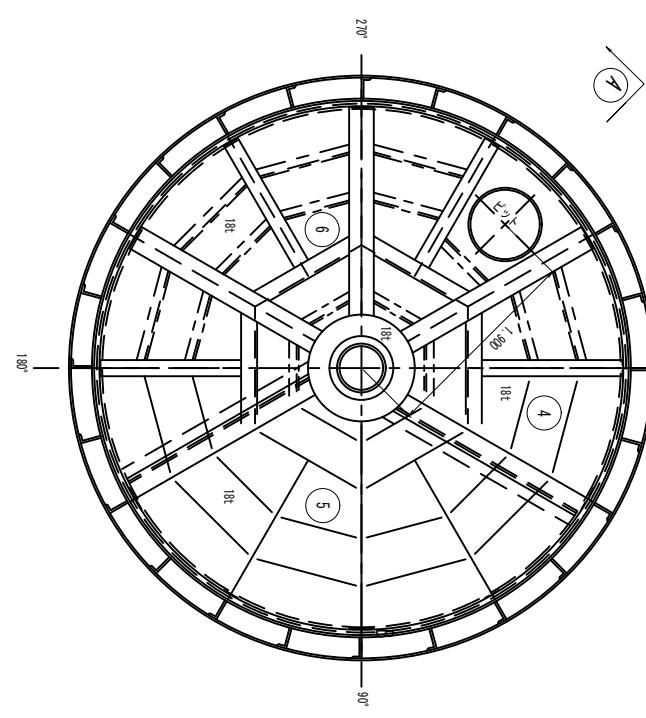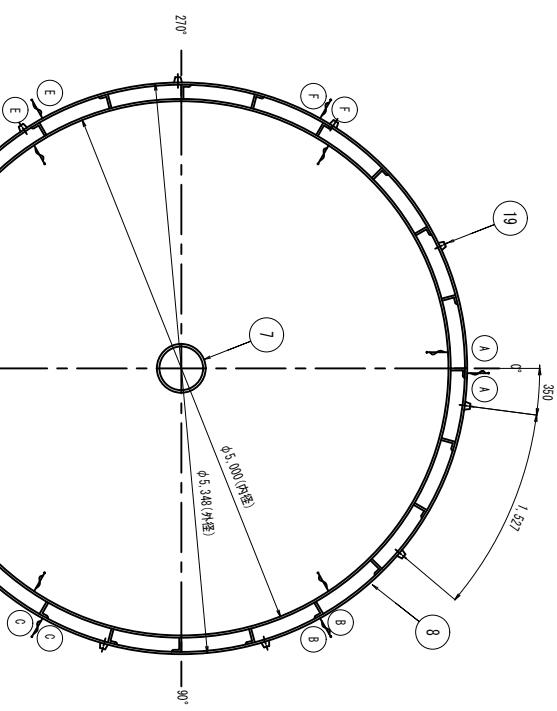

⑨ 下部セグメント組立平面図

(11) ピット用栗石止め据付平面図

卷之三

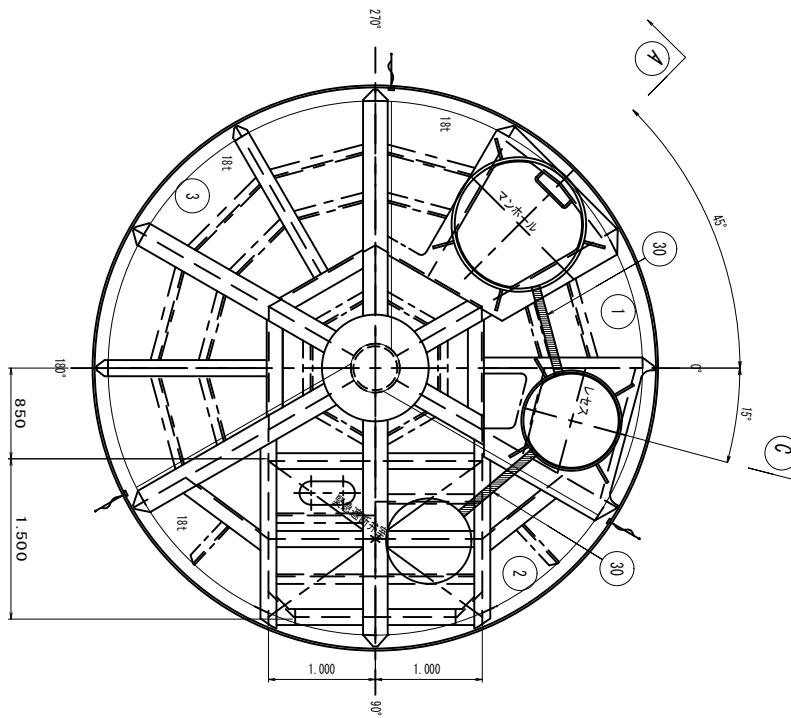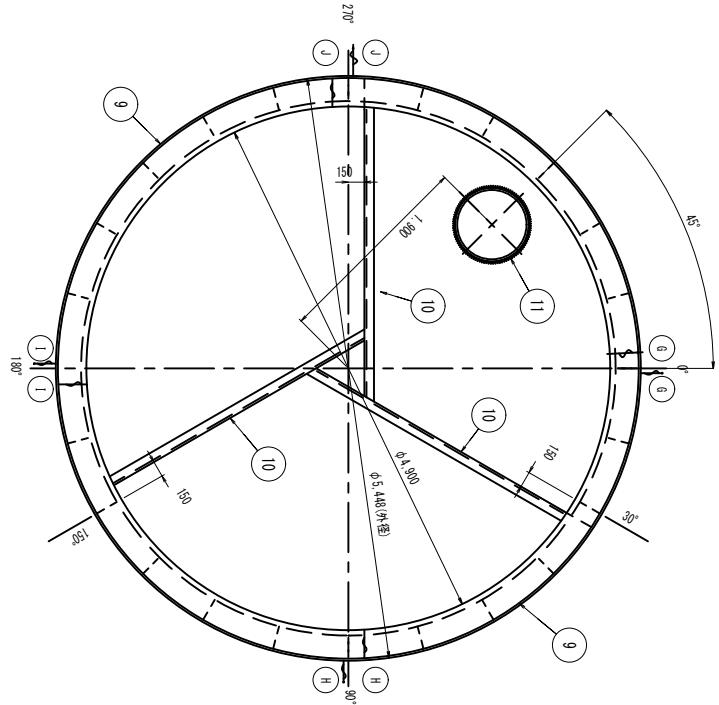

頂版組立平面図

/ 1

151

145°

30 -

アシホウ

1000

卷之三

卷之三

184

卷之三

A schematic diagram of a curved pipe system. A horizontal line extends from the bottom right, turns upwards and to the left at a 45-degree angle, and then turns vertically upwards. A small rectangular valve is positioned on the vertical segment of the pipe.

100
850
1

【参考図】
※この図面はA2サイズを原寸とする


336 里 里 30945.7

工事名	平成31年度工務防災補第1号 久居駅東口耐震性貯水槽設置工事		
施工箇所名	津市 久居新町 地内		
図面の種類	耐震性貯水槽 組立施工図(1)		
縮尺	図示	図面番号	3/15
事業所名	津市水道局工務課		

耐震性貯水槽 組立施工図(2)


セグメント組立立面図

S=1:50

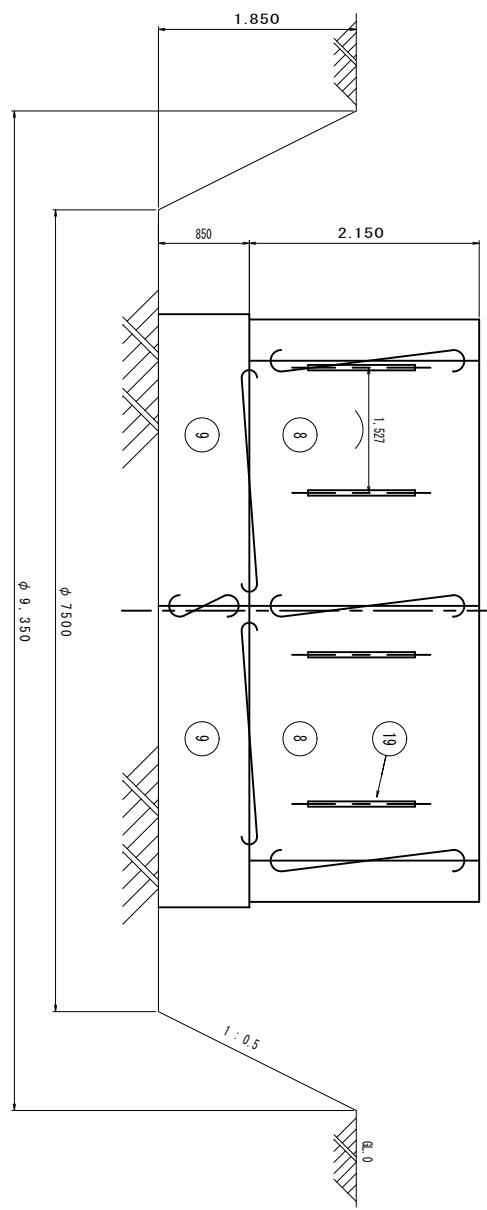


B 断面
S=1:25

10

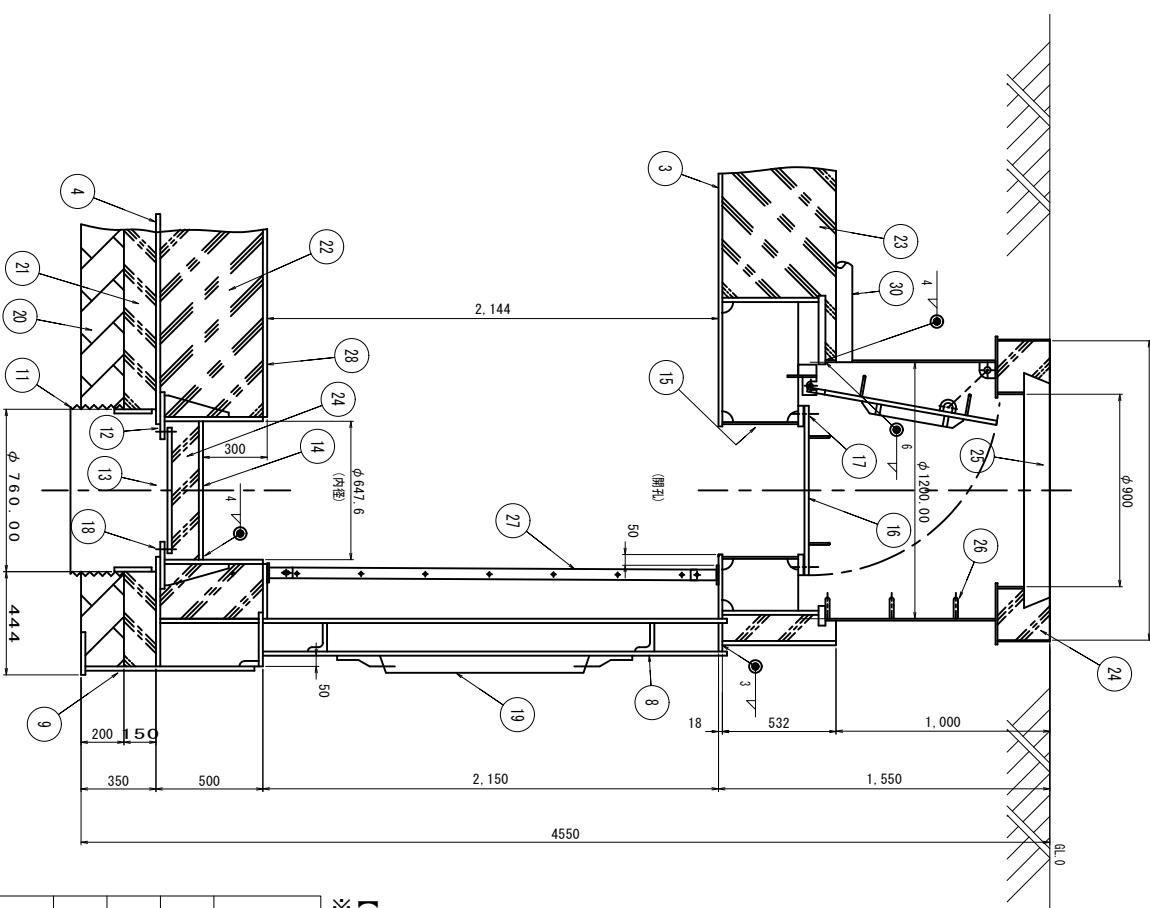

A 断面図
S=1:25

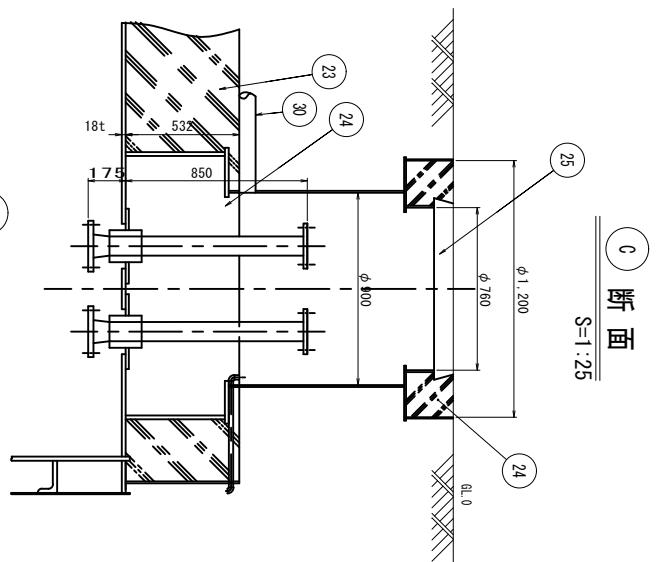

c 断面

S=1:2

【参考図】
※この図面はA2サイズを原寸とする


工事名	平成31年度工務防災補第1号 久居駅東口耐震性貯水槽設置工事		
施工箇所名	津市 久居新町 地内		
図面の種類	耐震性貯水槽 組立施工図(2)		
縮尺	図示	図面番号	4/15
事業所名	津市水道局工務課		

耐震性貯水槽 セグメント詳細図(1)

(8) 上部セグメント頂板平面


平面

(B) ~ B 斷面(展開面)

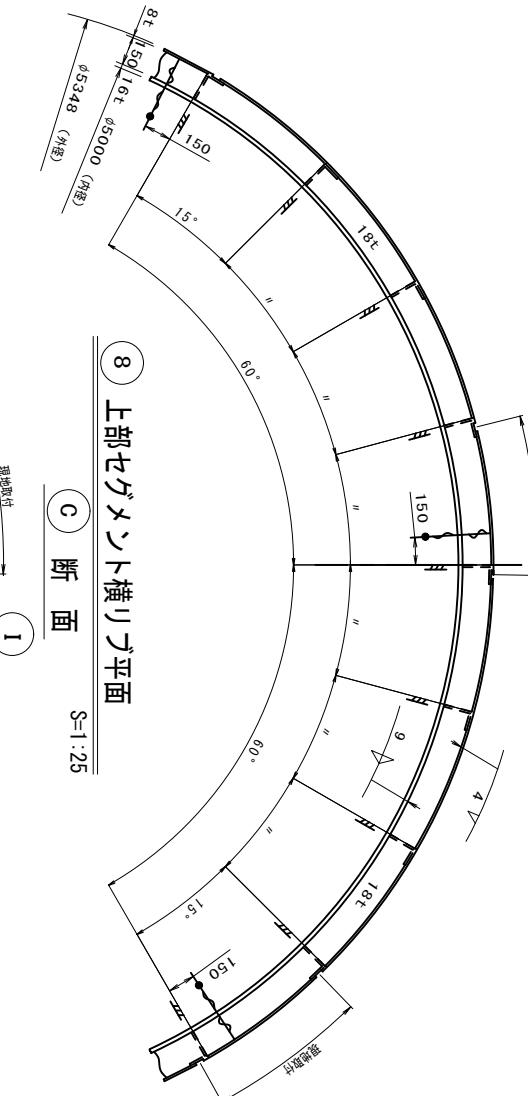


8 上部セグメント横リラ平面

ラメント横リラ

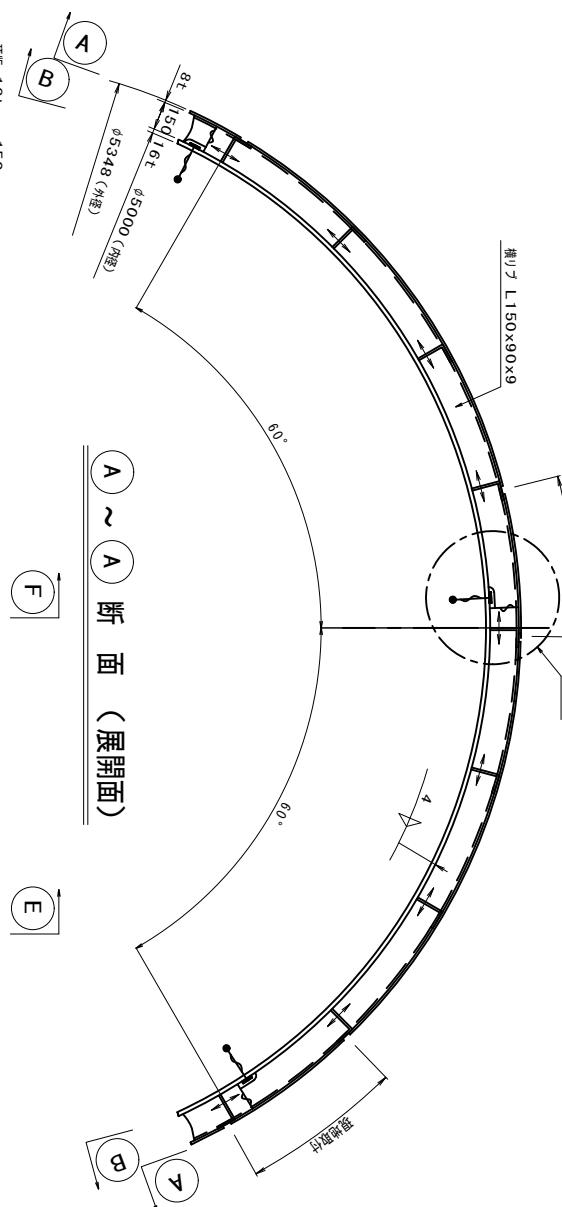


A ~ A 斷面(展開面)

A 断面

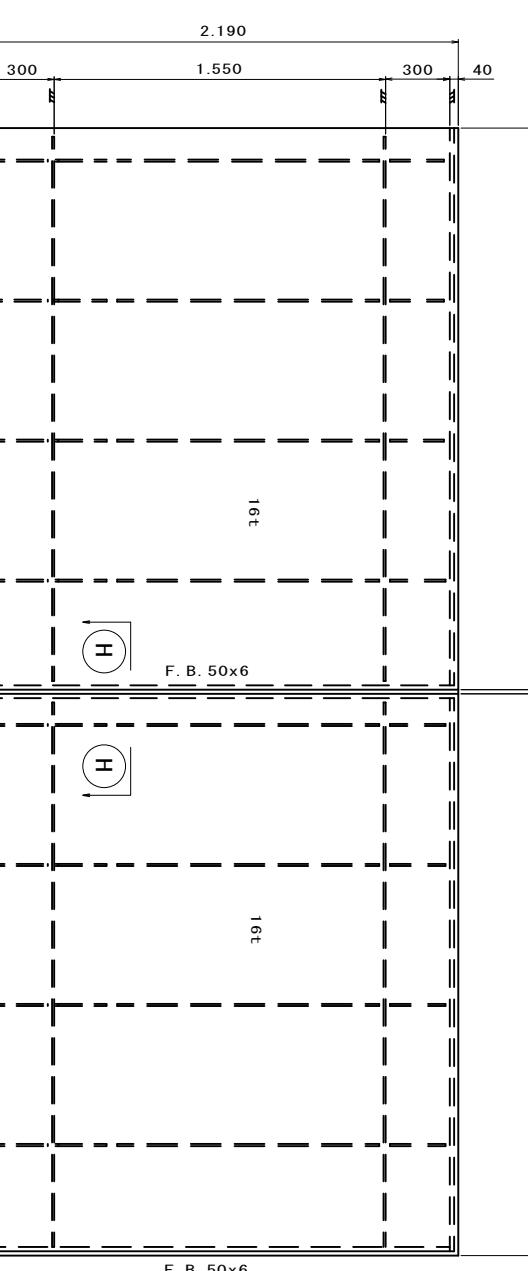

100


- - -

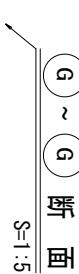

スロット溶接詳細

総重量 12147.9kg

【参考図】
※この図面はA2サイズを原寸とする

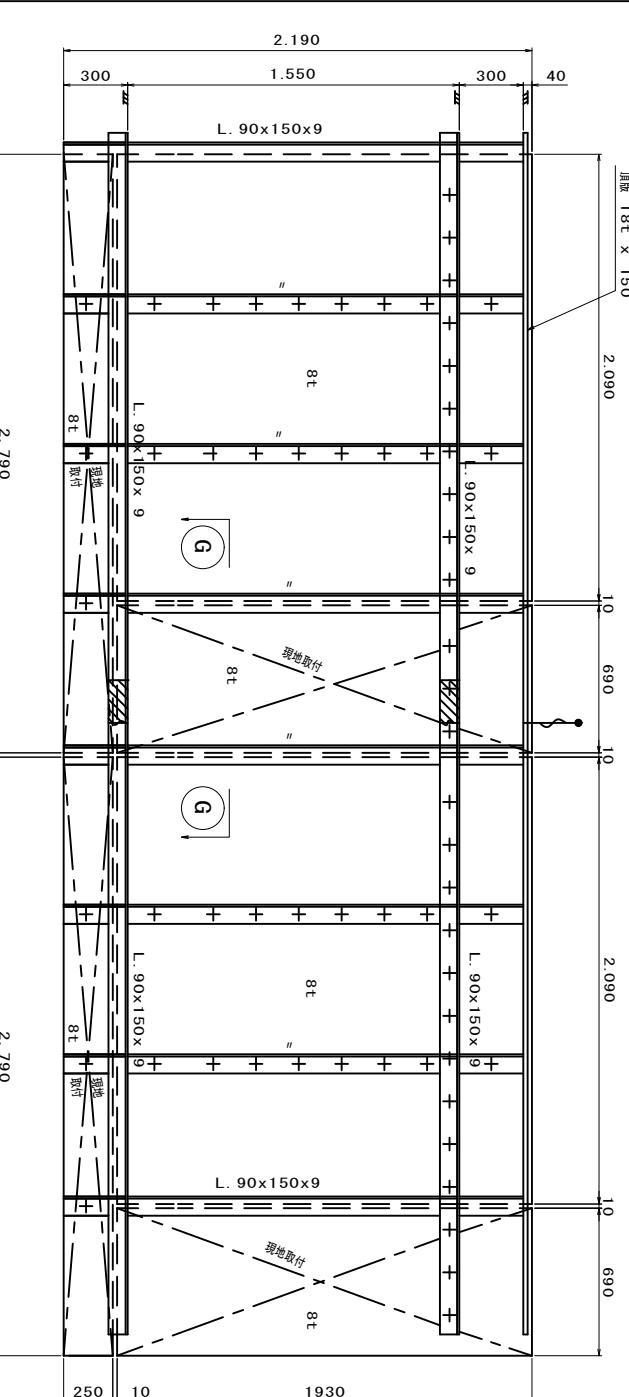


【参考図】
※この図面はA2サイズを原寸とする

工事名	平成31年度工務防災補第1号 久居駅東口耐震性貯水槽設置工事		
施工箇所名	津市 久居新町 地内		
面図の種類	耐震性貯水槽 セグメント詳細図(1)		
縮尺	図示	図面番号	5/15
事業所名	津市水道局工務課		

耐震性貯水槽 セグメント詳細図(2)

設 計 図

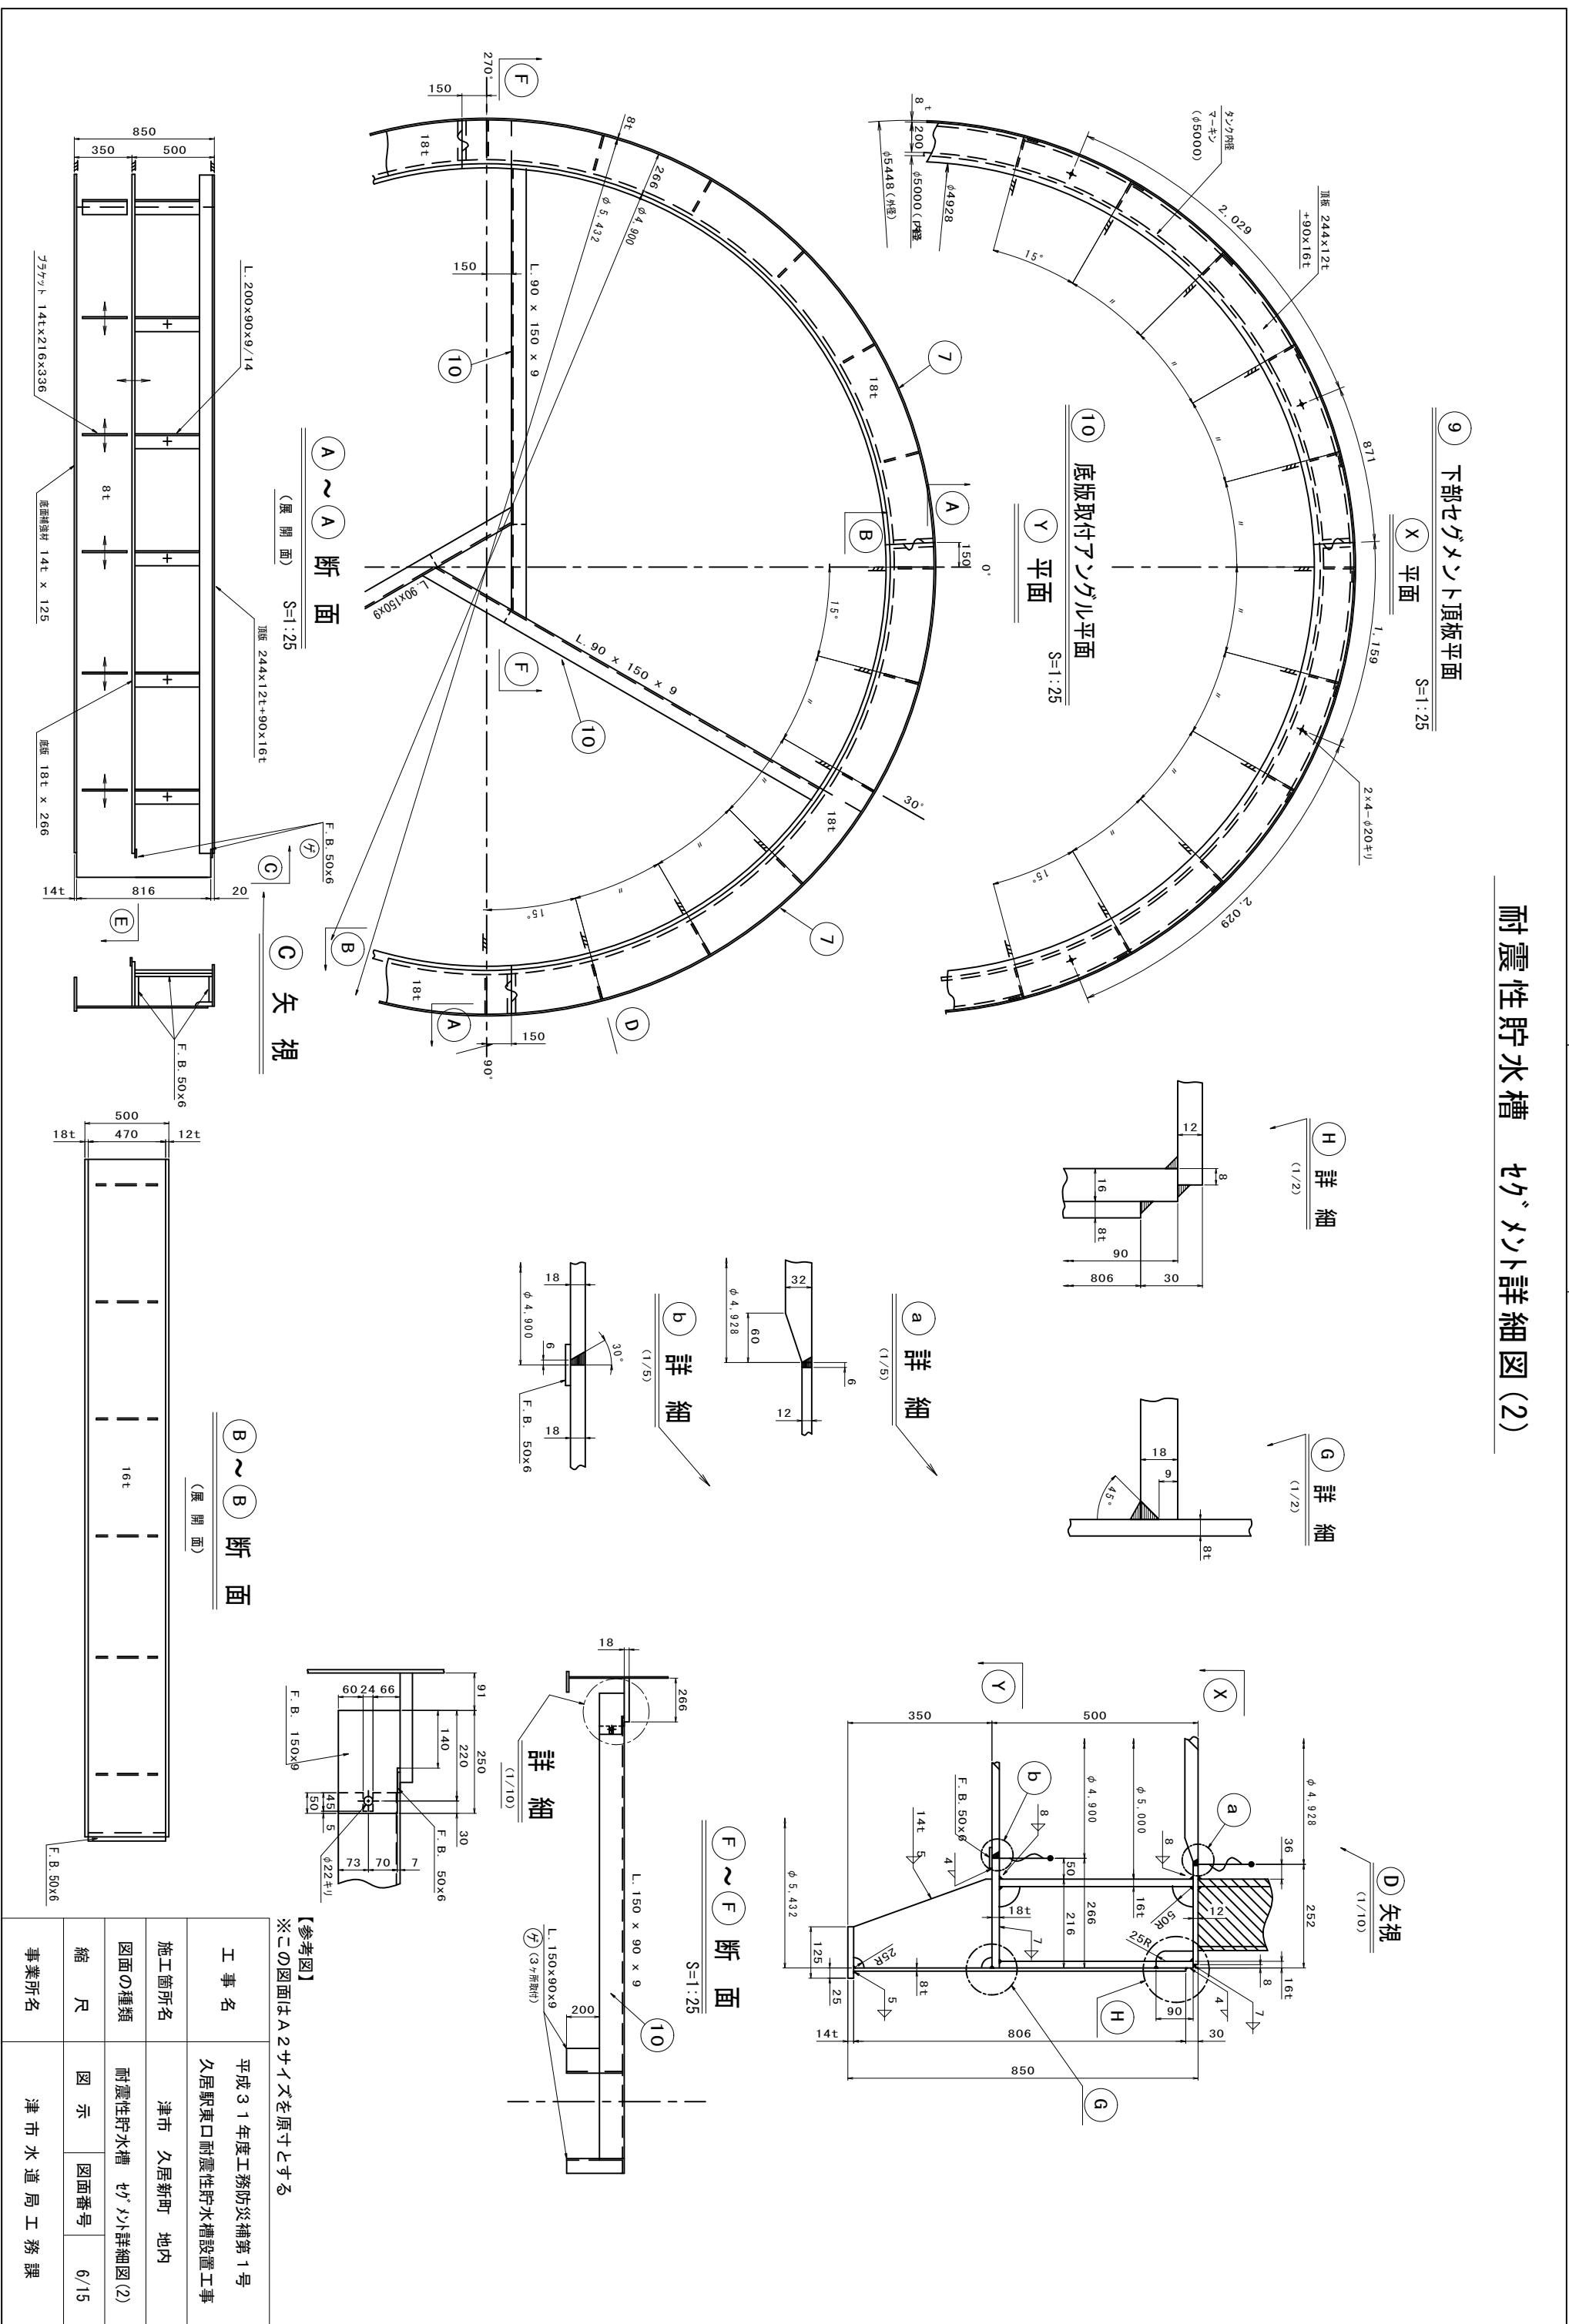


耐震性貯水槽 底版及び支柱工詳細図(1)

設 計 図

底版組立平面図 S=1:30

底版組立平面図 S=1:30

注: ~
1. 圖中○について: 現地にて取付とする。
2. ○底盤板は第2回コンクリート施工後
現地にて取付のこと。

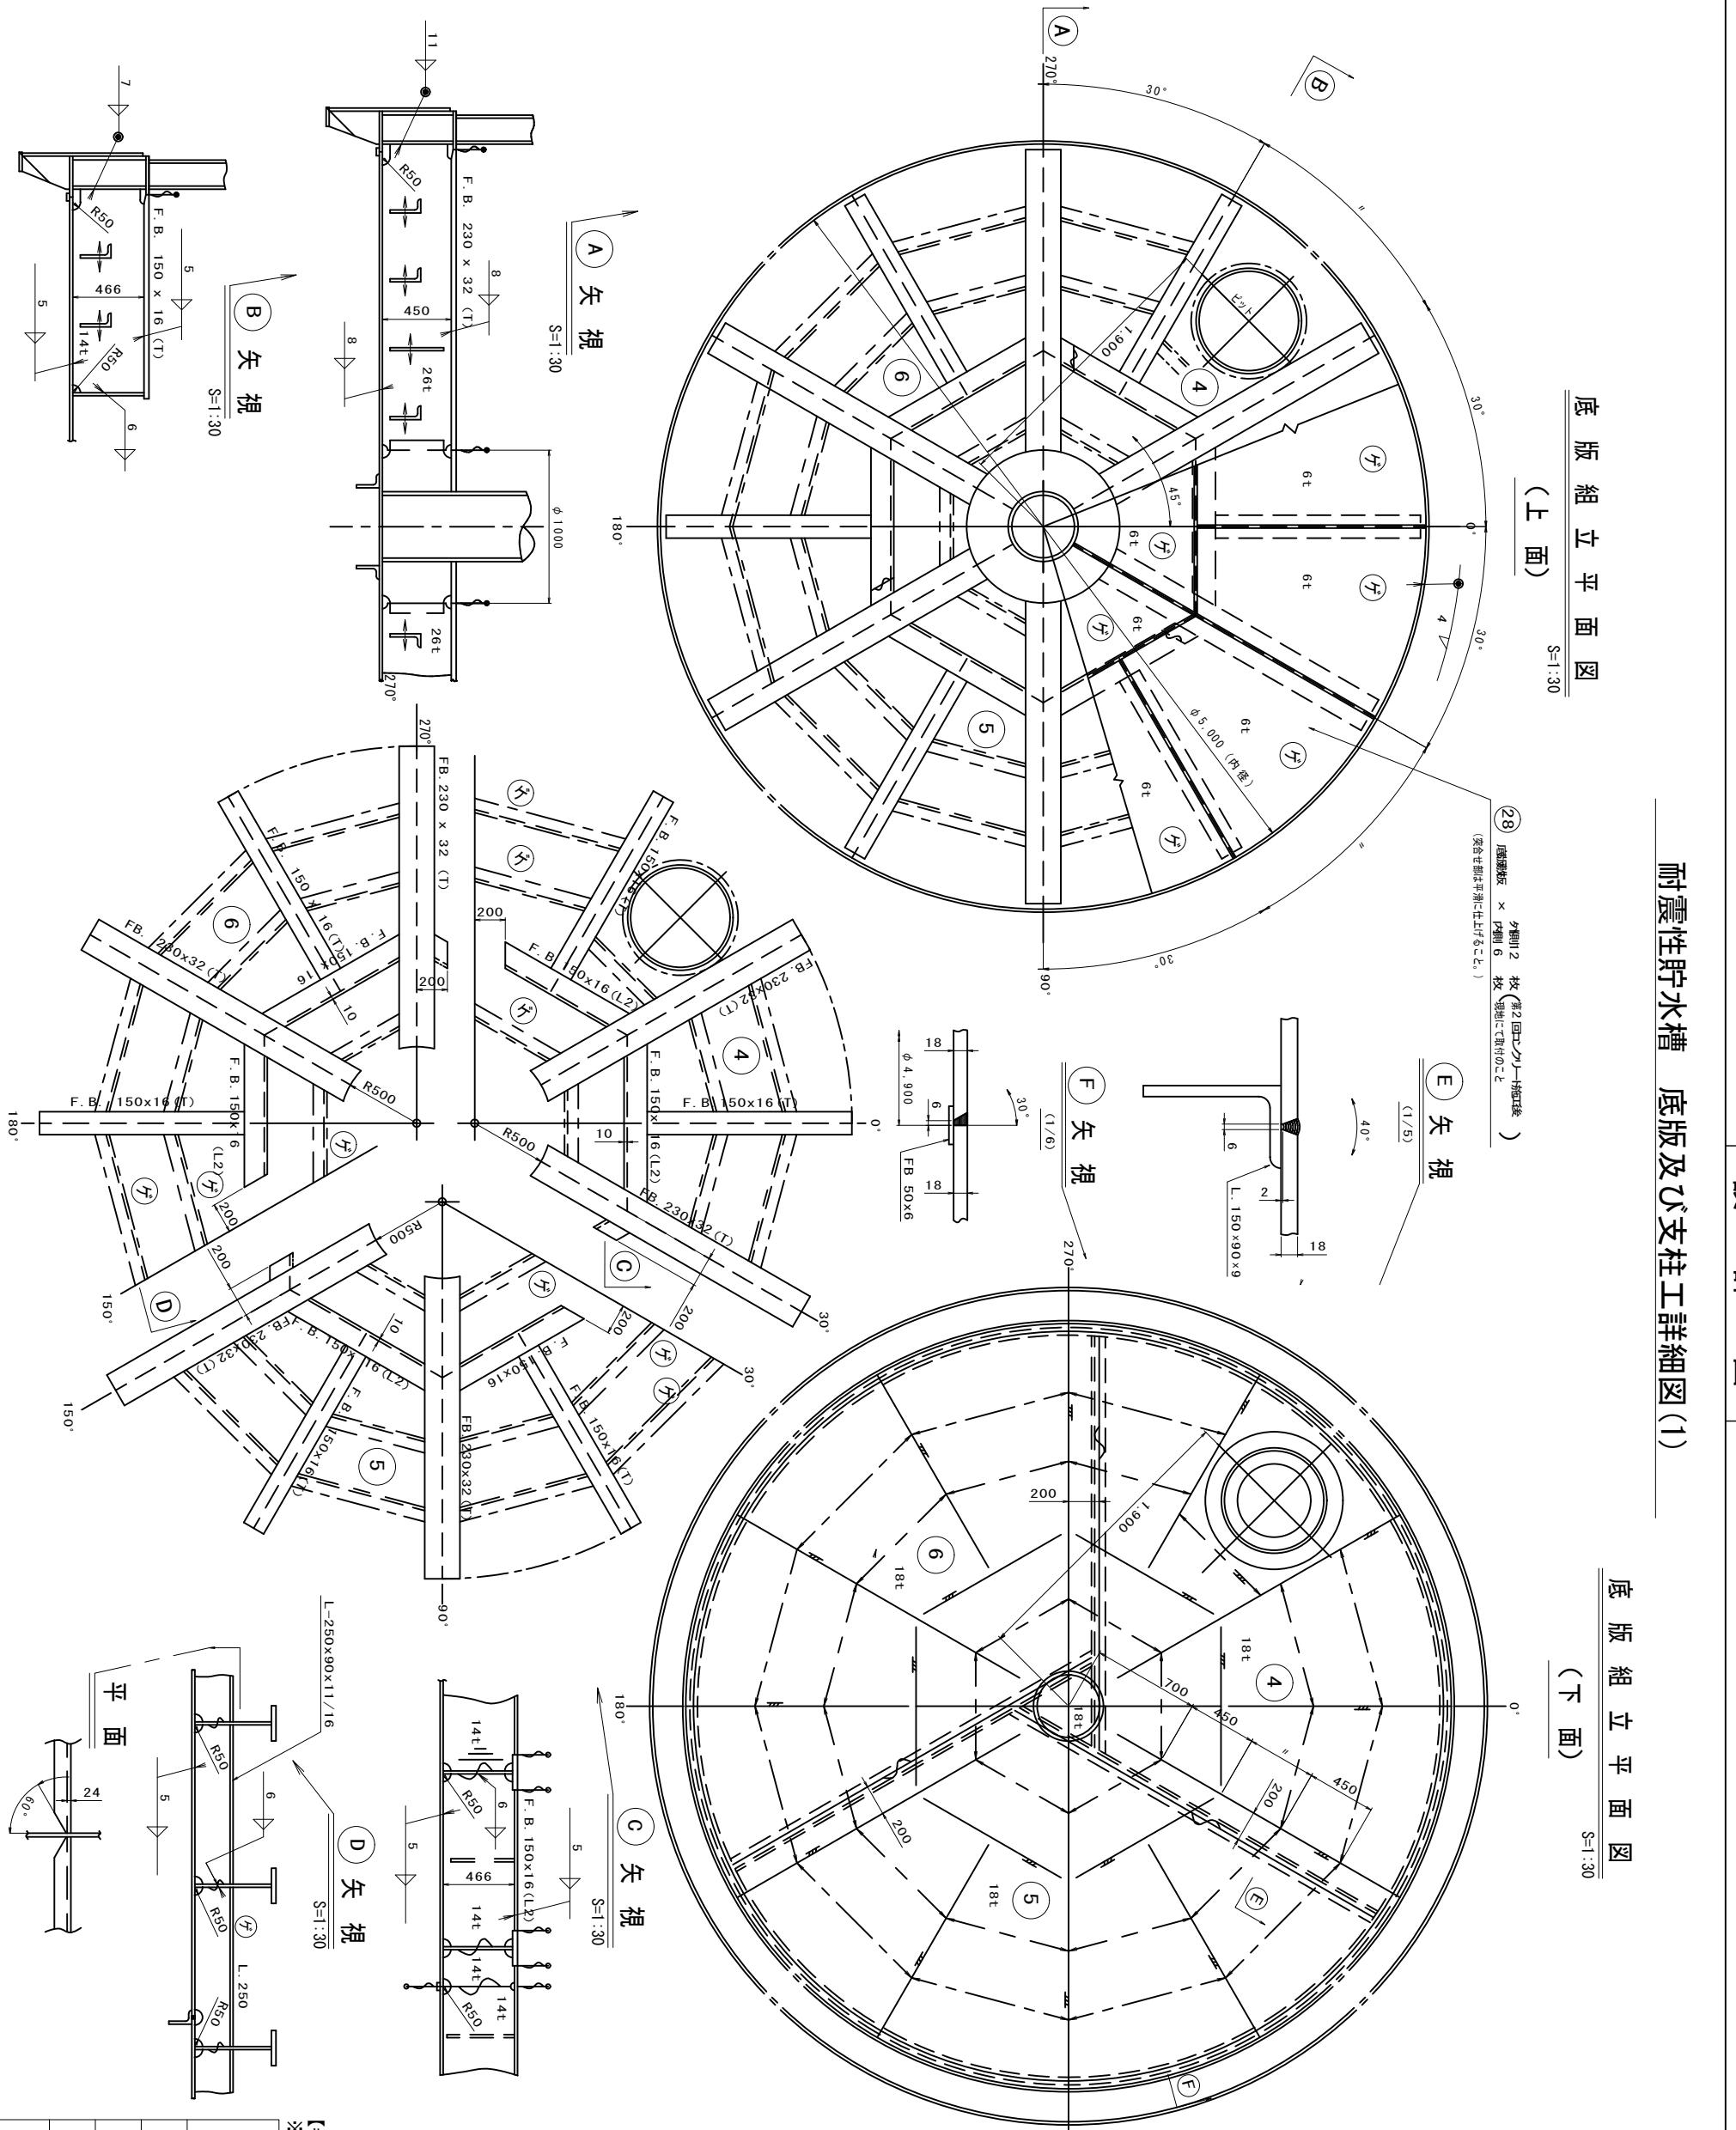


【参考図】
※この図面はA2サイズを原寸とする

工事名		平成31年度工務防災補第1号		
施工箇所名		久居駅東口耐震性貯水槽設置工事		
図面の種類		耐震性貯水槽 底版及び支柱工詳細図(1)		
縮 尺	図 示	図面番号	7/15	
事業所名	津市水道局工務課			
総 重 量	9056.6 kg			
(23) 鋼板 PL-6	SS 400 18 —	924.0	(23) 1 1/4 kg	
(15) 鋼板 PL-6x45.5	SS 400 18	0.2	(15) 3 1/4 kg	
(14) 上蓋 PL-6x45.5	SS 400 1	15.4	(14) 15.4 kg	
(13) M20ナット	SS 400 2	0.1	(13) 40.0 kg	
(12) 下蓋 PL-18x46.00	SS 400 1	40.0	(12) 40.0	
(11) ピン用ハッキン	SS 400 1	—	(11) 18.7 kg	
(1) フレーム 4.5x4760X150	SS 400 1	9.0	(1) 11.1 kg	
(7) 折版 PL-26x336X450	SS 400 12	30.9	(7) 37.0 kg	(現勘)
(6) 折版 PL-32x11000x450	SS 400 1	155.5	(6) 155.5 kg	(現勘)
(5) 支柱 PL-32x10000	SS 400 1	197.3	(5) 197.3 kg	(現勘)
(4) 支柱 PL-22x23.8x3100 SPB 38	1	187.4	(4) 187.4 kg	
防護材 L-250x90x1/4x10/4	SS 400 2	2.2	(4) 2.2 kg	
折版 FB-16x150x44	FB-16x150x44	1	(4) 1.6 kg	
折版 FB-16x150x104	FB-16x150x104	1	(4) 1.6 kg	
防護材 L-250x90x1/4x75/6	SS 400 1	2.2	(4) 2.2 kg	
折版 FB-32x230x952	FB-32x230x952	2	(4) 2.2 kg	
折版 FB-16x150x63	FB-16x150x63	1	(4) 1.6 kg	
折版 FB-16x150x104	FB-16x150x104	1	(4) 1.6 kg	
防護材 L-250x90x1/4x75/6	SS 400 1	2.2	(4) 2.2 kg	
折版 FB-16x150x44	FB-16x150x44	1	(4) 1.6 kg	
折版 FB-16x150x104	FB-16x150x104	1	(4) 1.6 kg	
防護材 L-250x90x1/4x75/6	SS 400 1	2.2	(4) 2.2 kg	
折版 FB-16x150x44	FB-16x150x44	1	(4) 1.6 kg	
折版 FB-16x150x104	FB-16x150x104	1	(4) 1.6 kg	
防護材 L-250x90x1/4x75/6	SS 400 1	2.2	(4) 2.2 kg	
折版 FB-16x150x44	FB-16x150x44	1	(4) 1.6 kg</td	

耐震性貯水槽 底版及び支柱工詳細図(2)













































































































































































設 計 図

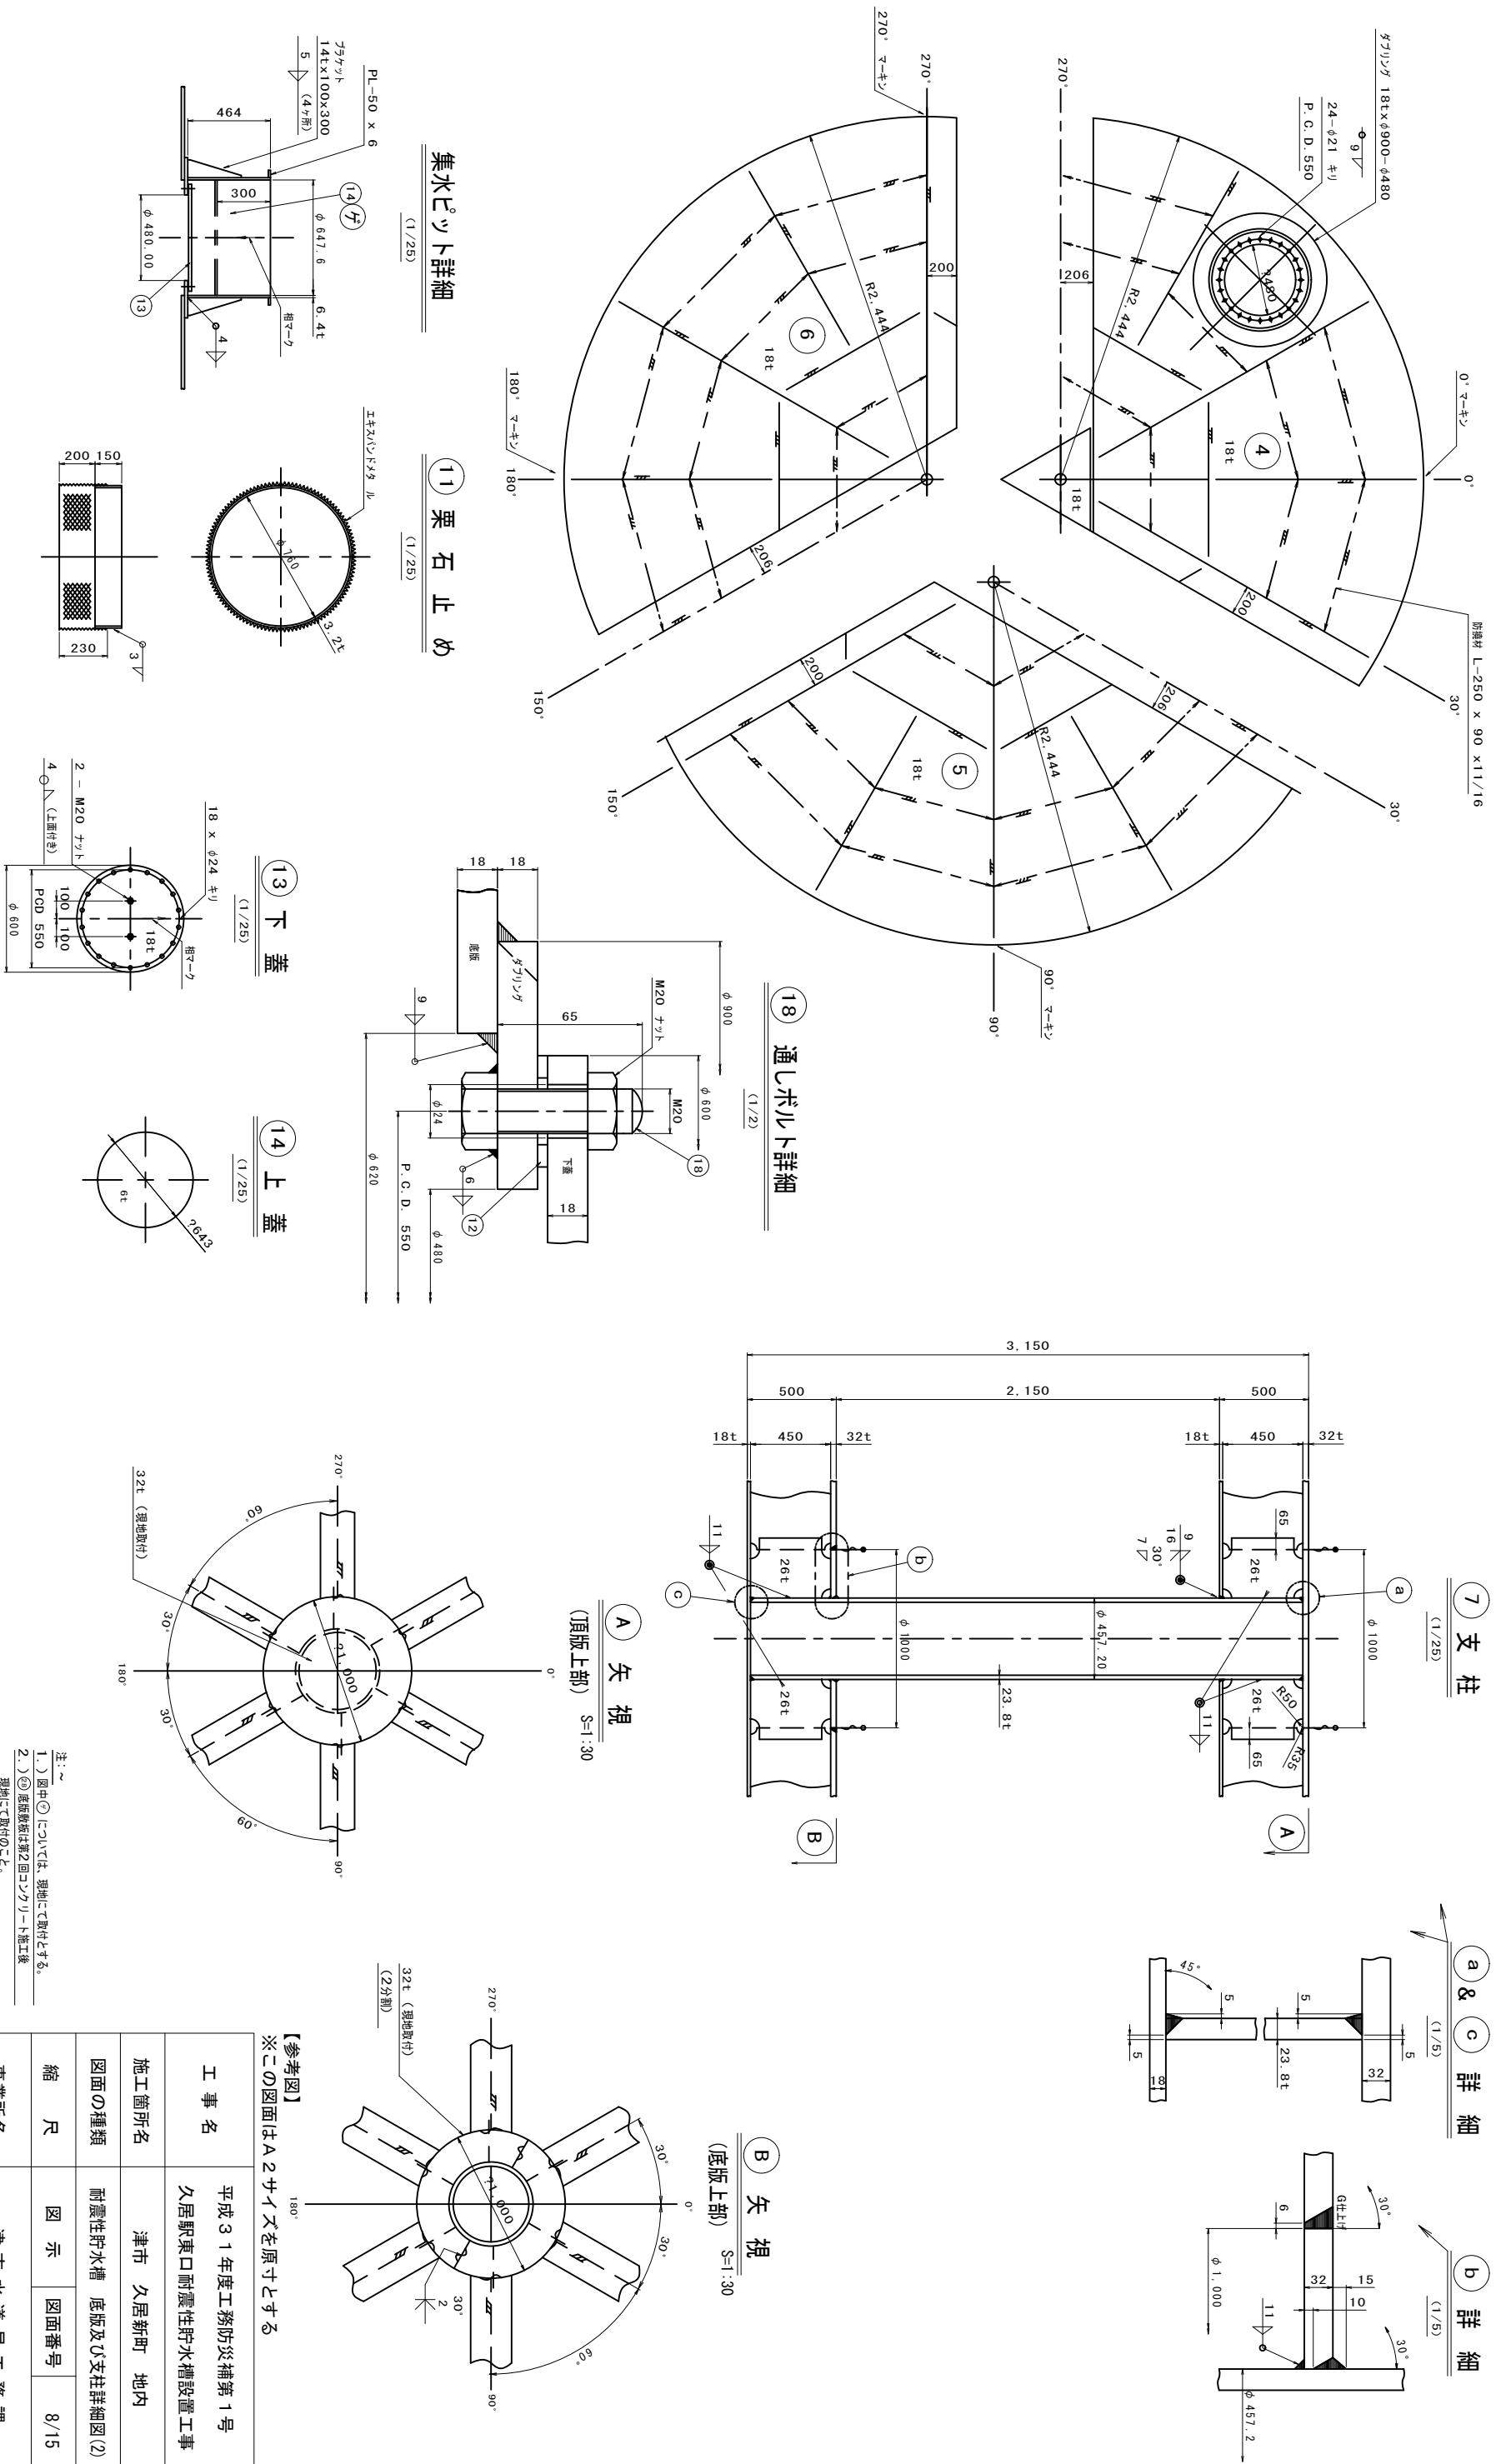

頂版組立平面図

(上面)

S=1:30

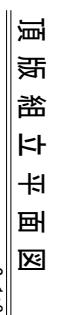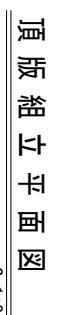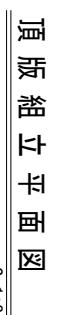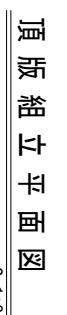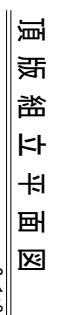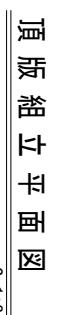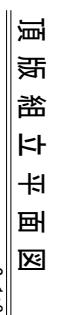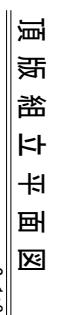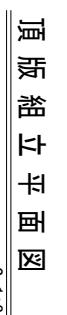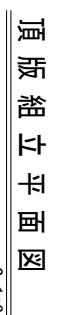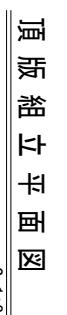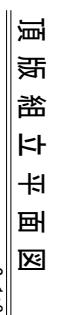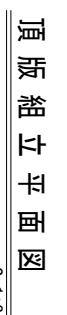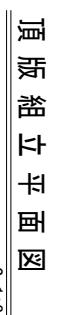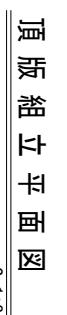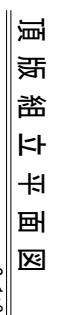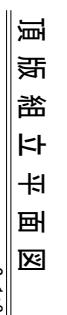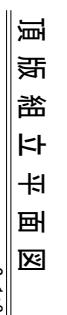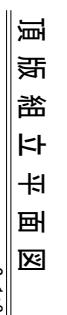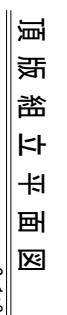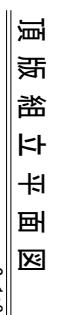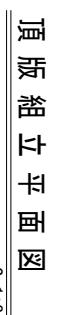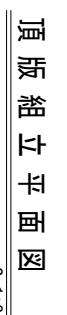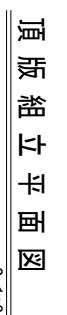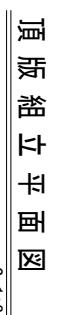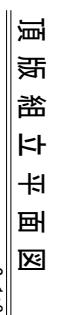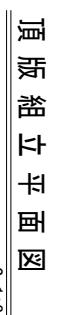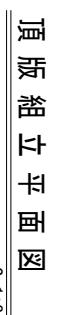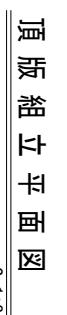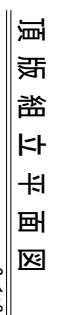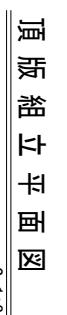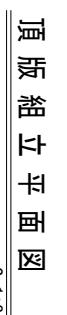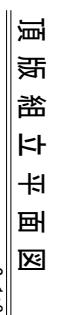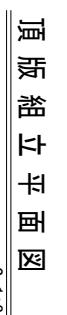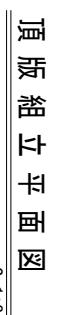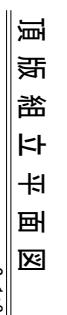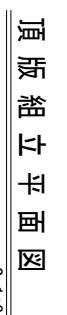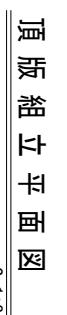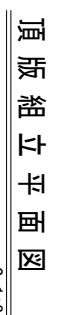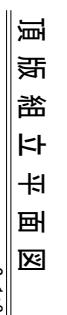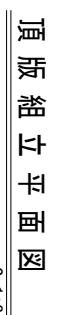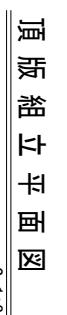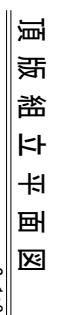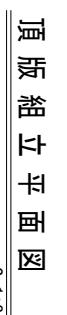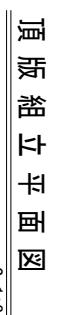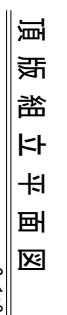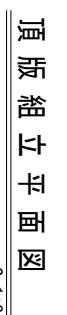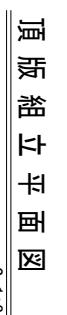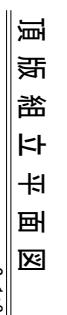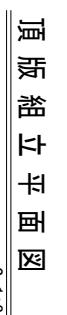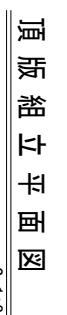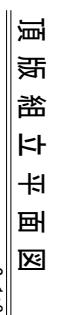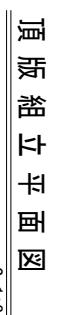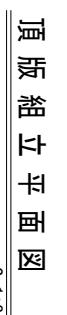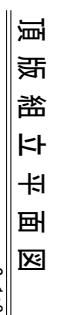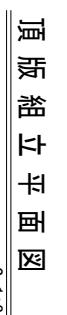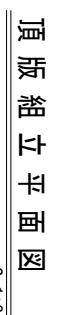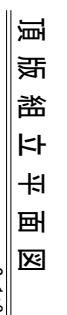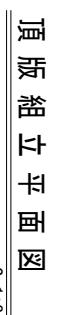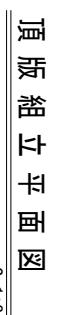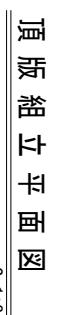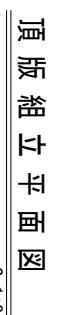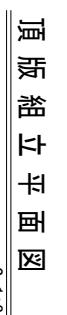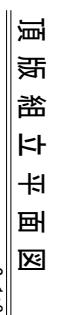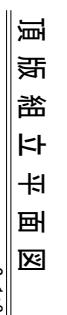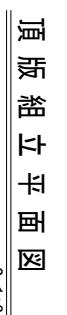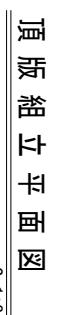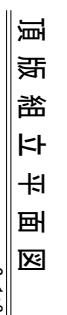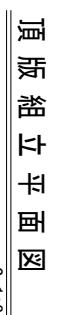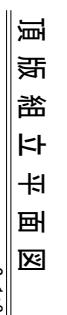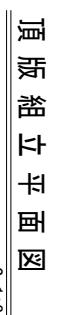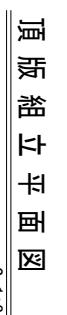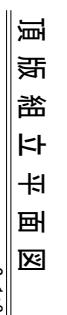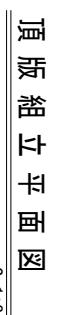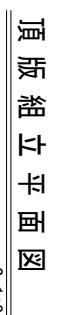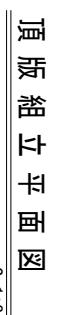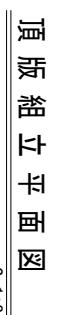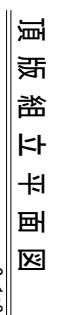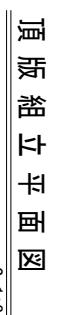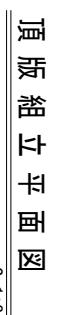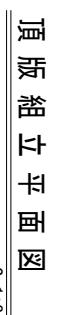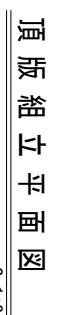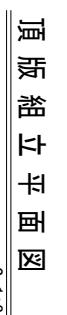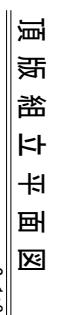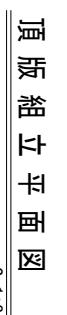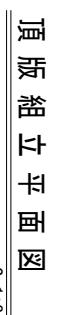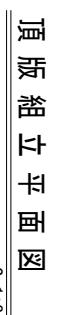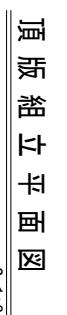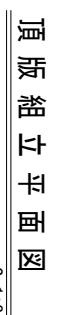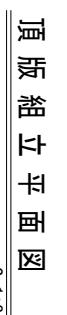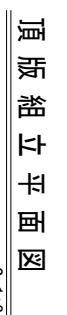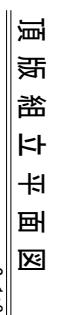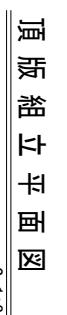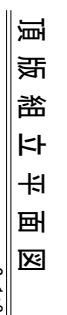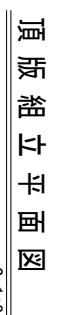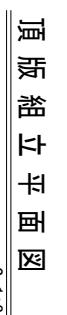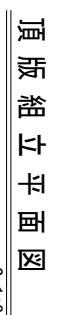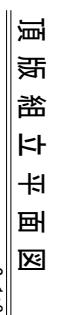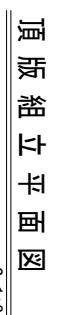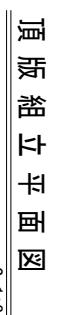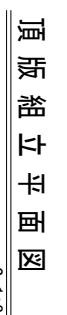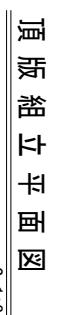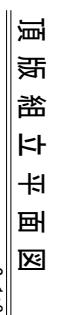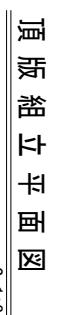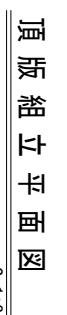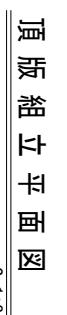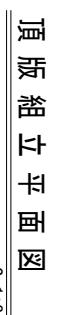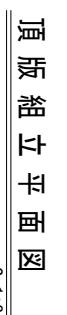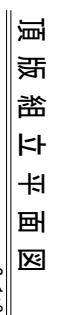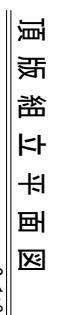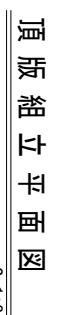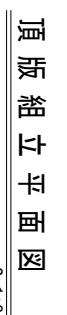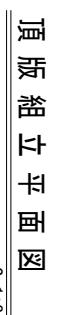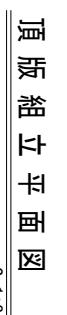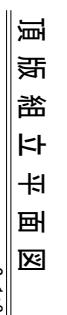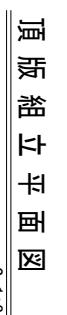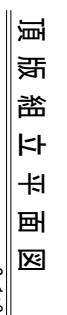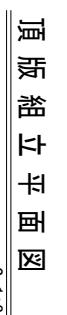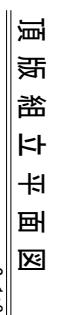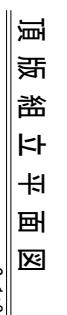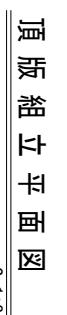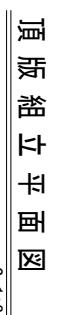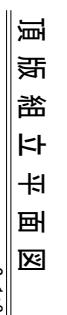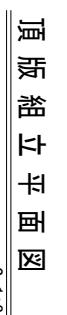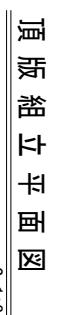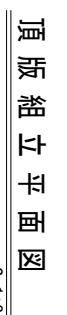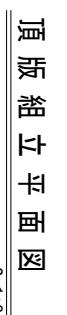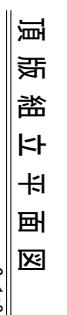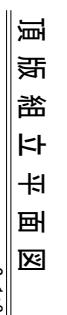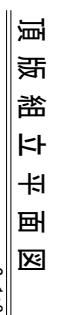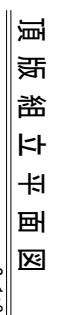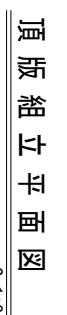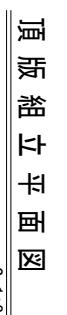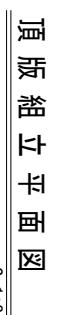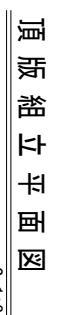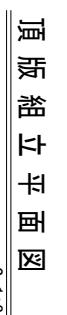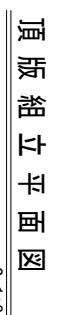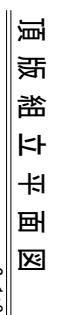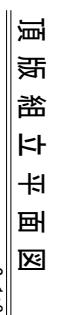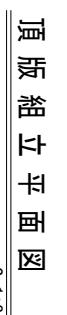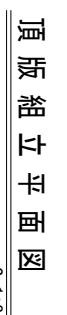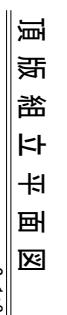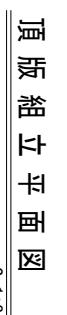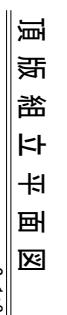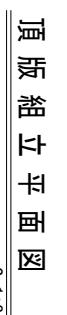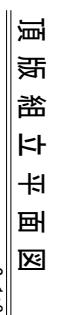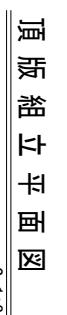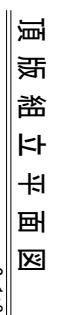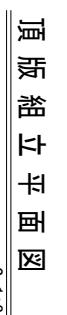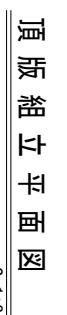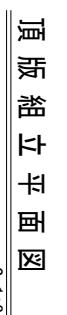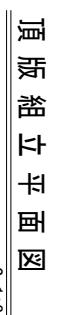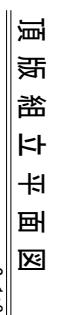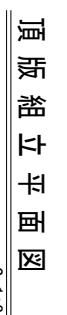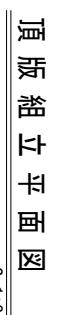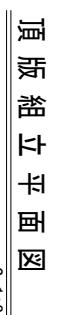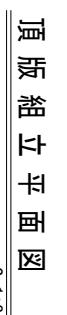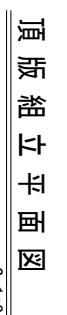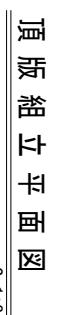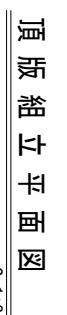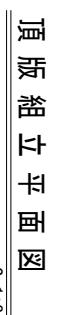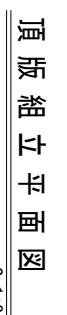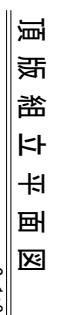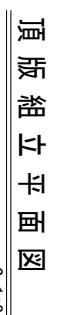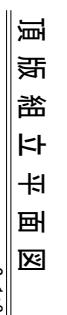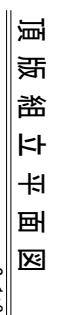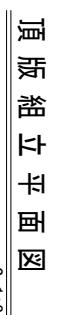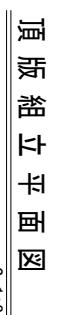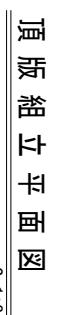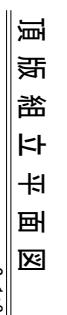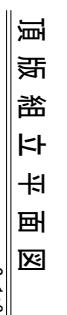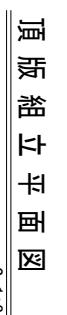


耐震性貯水槽 内配管図

S=1:40


(C) 及び (D) 断面

(自動給水装置)

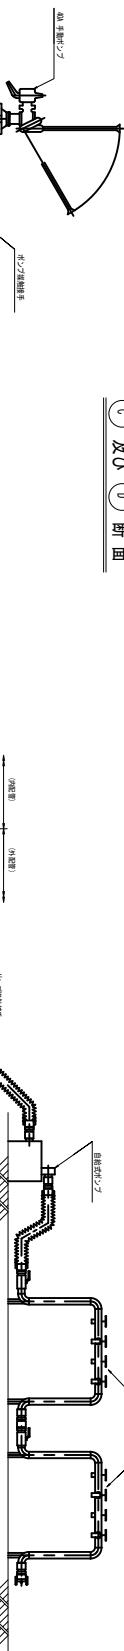


(注) 緊急遮断弁「閉」の状態における吸水管渠(消防用)には、併用型 金具をねじ込み式対応にしてご利用願います。


(E) 矢 視

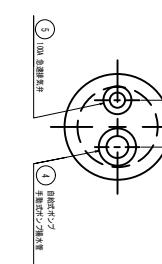


(F) 矢 視

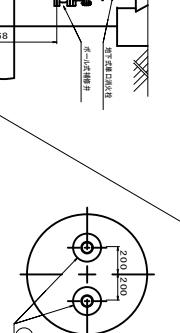


(G) 矢 視

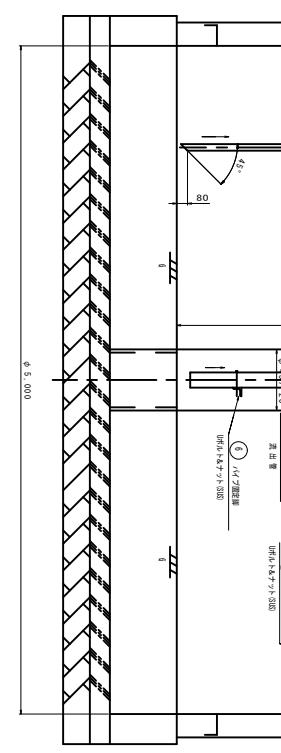


(H) 矢 視

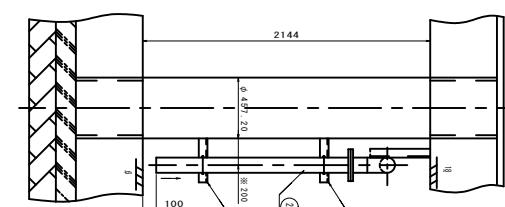

(I) 断面

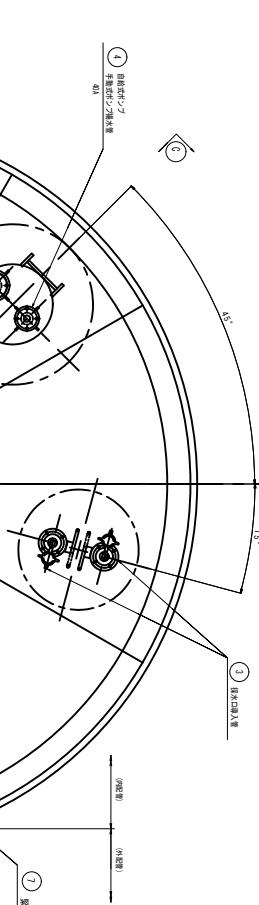

(J) 断面

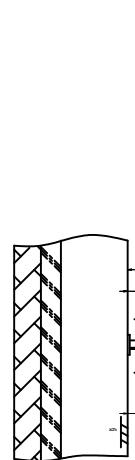

[参考図]
※この図面はA2サイズを原寸とする

工事名	平成31年度工務防災補第1号		
施工箇所名	久居駅東口耐震性貯水槽設置工事 津市 久居新町 地内		
図面の種類	耐震性貯水槽 内配管図		
縮尺	図示	図面番号	12/15
事業所名	津市水道局工務課		

耐震性貯水槽 装備品詳細図

設 計 図

27 垂直梯子

101/10

1
2 貴通部詳細
(1/10)


101

3 買通部詳細


(01/1)

4 目錄小表單



S=1:25

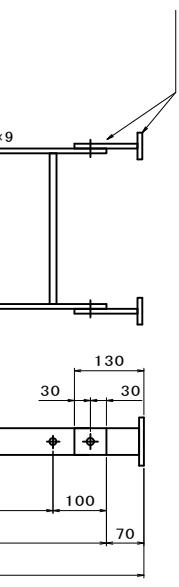


F. B. 50

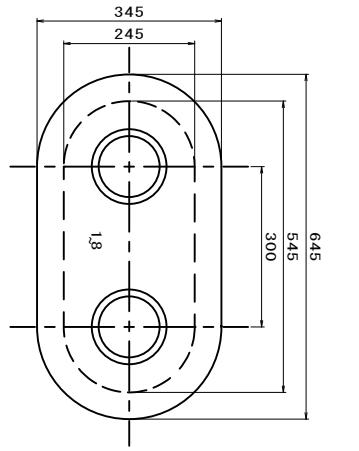


100A用

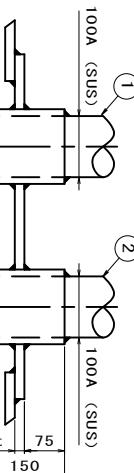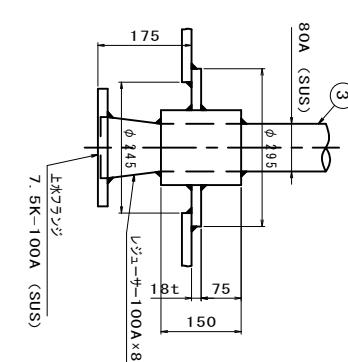

Schematic diagram of a 100A (SUS) shunt connected to terminal 1.

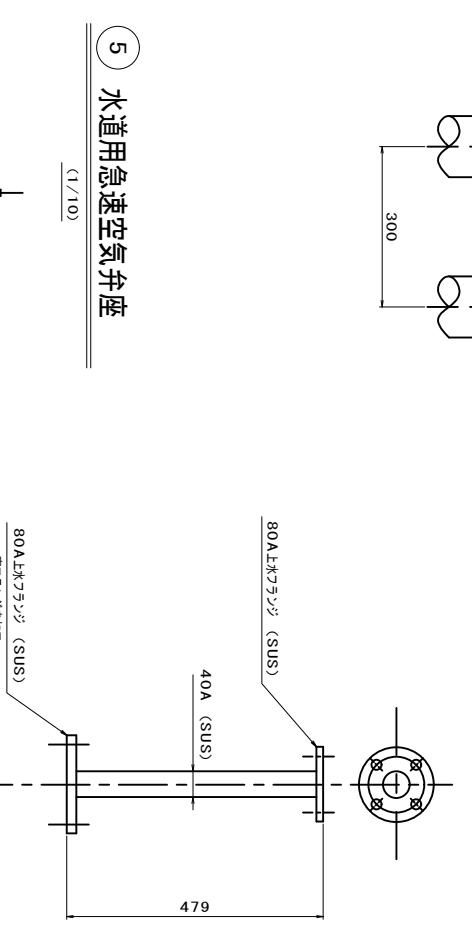


5 水道用急速空気弁座

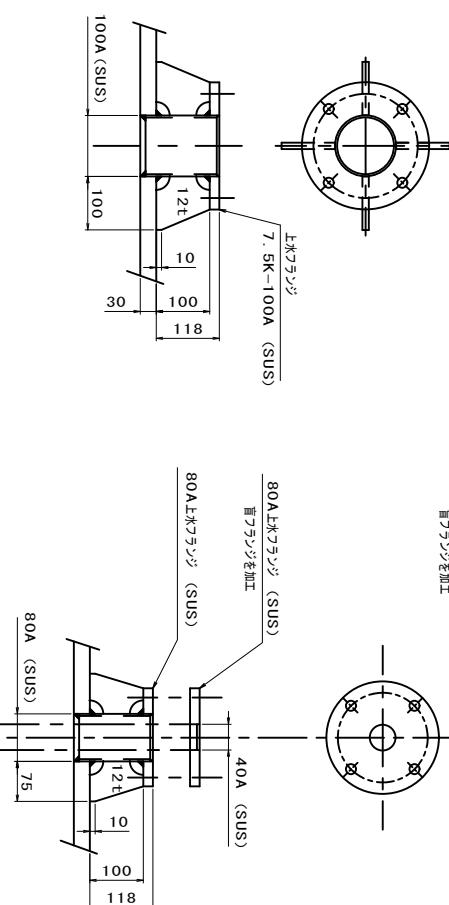

100A (SUS) 100

【参考図】

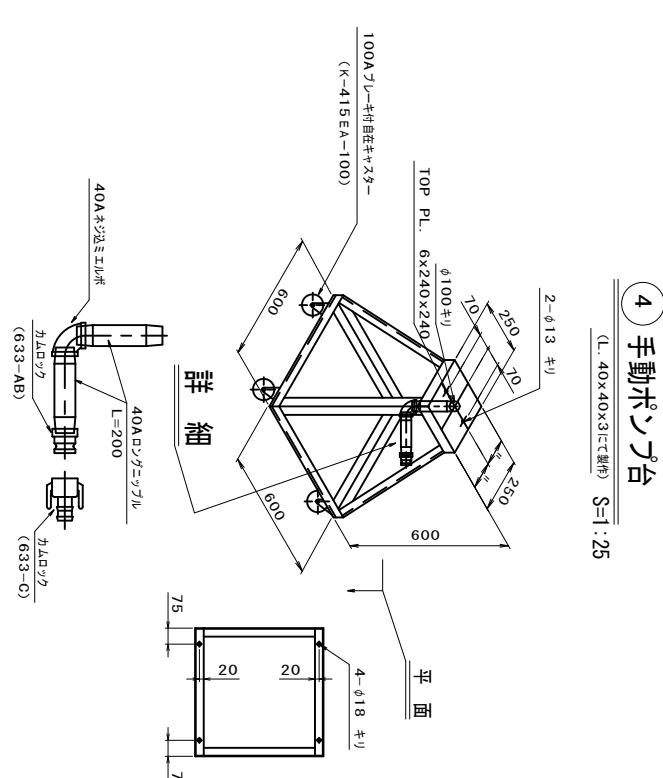

【参考図】	
工事名	※この図面はA2サイズを原寸とする 平成31年度工務防災補第1号

工事名
久居駅東口耐震性貯水槽設置工事
平成31年度工務局火災備防 11-5



施工箇所名	津市	久居新町	地内
図面の種類	耐雪性時水塙	生機品	詳細図

事業所名 津市水道局工務課


設 計 図

横断面図
S=1 : 100

掘削及び埋戻工法図
S=1 : 20

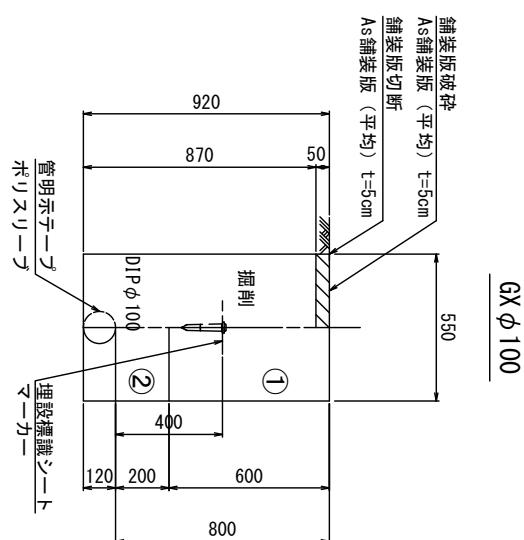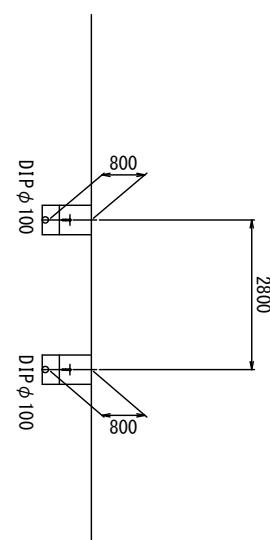

掘 削	0. 34
埋 戻 し (3)	0. 22
埋 戻 し (4)	0. 14
舗装版切断	2. 0
舗装版破碎 (2)	0. 55

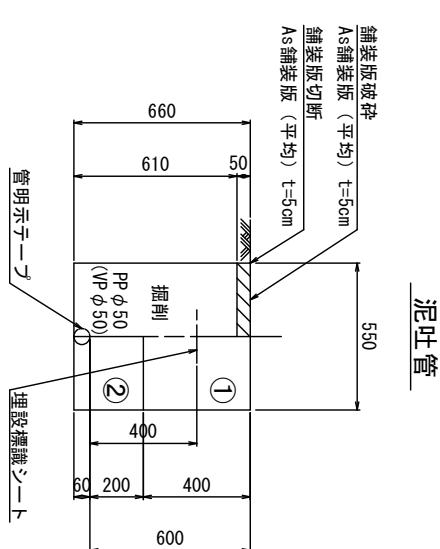

※この図面はA2サイズを原寸とする

工事名	平成31年度工務防災補第1号 久居駅東口耐震性雨水槽設置工事	
施工箇所名	津市 久居新町 地内	
図面の種類	横断面図 掘削及び埋戻工法図	
縮 尺	図 示	図面番号 14/15
事業所名	津市水道局工務課	

- ① · · · 再生碎石 (RC-40)
- ② · · · 埋戻し用砂

設 計 図

配管詳細図 S=1 : 200


S=1 : 200

配管詳細図

S=1 : 200

A部詳細図

S=1 : 100

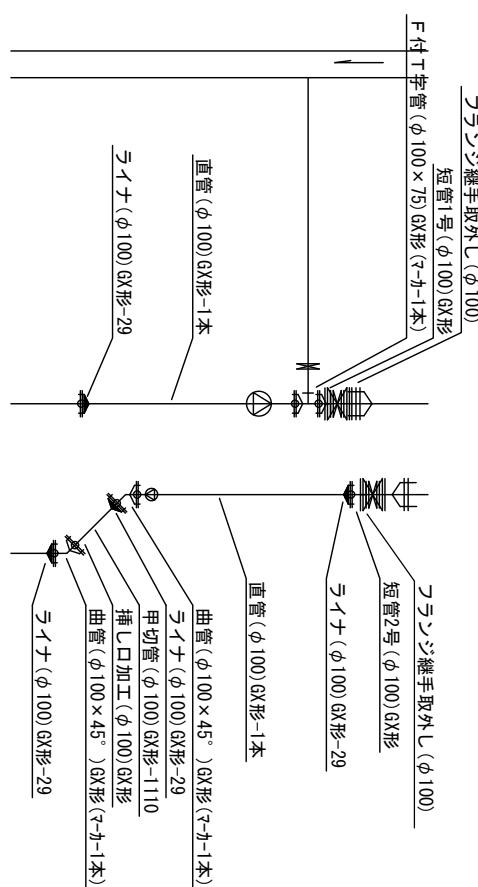


B部詳細図

S=1 : 100

B部

泥止工(φ50)
Pオネジソケット(φ50)-2個
ねじ金仕切弁(φ50)
金属入りハルブソケット(φ50)
PP(φ50)L=0.5m
VPエリボ(φ50)-3個
VP(φ50)L=5.4m

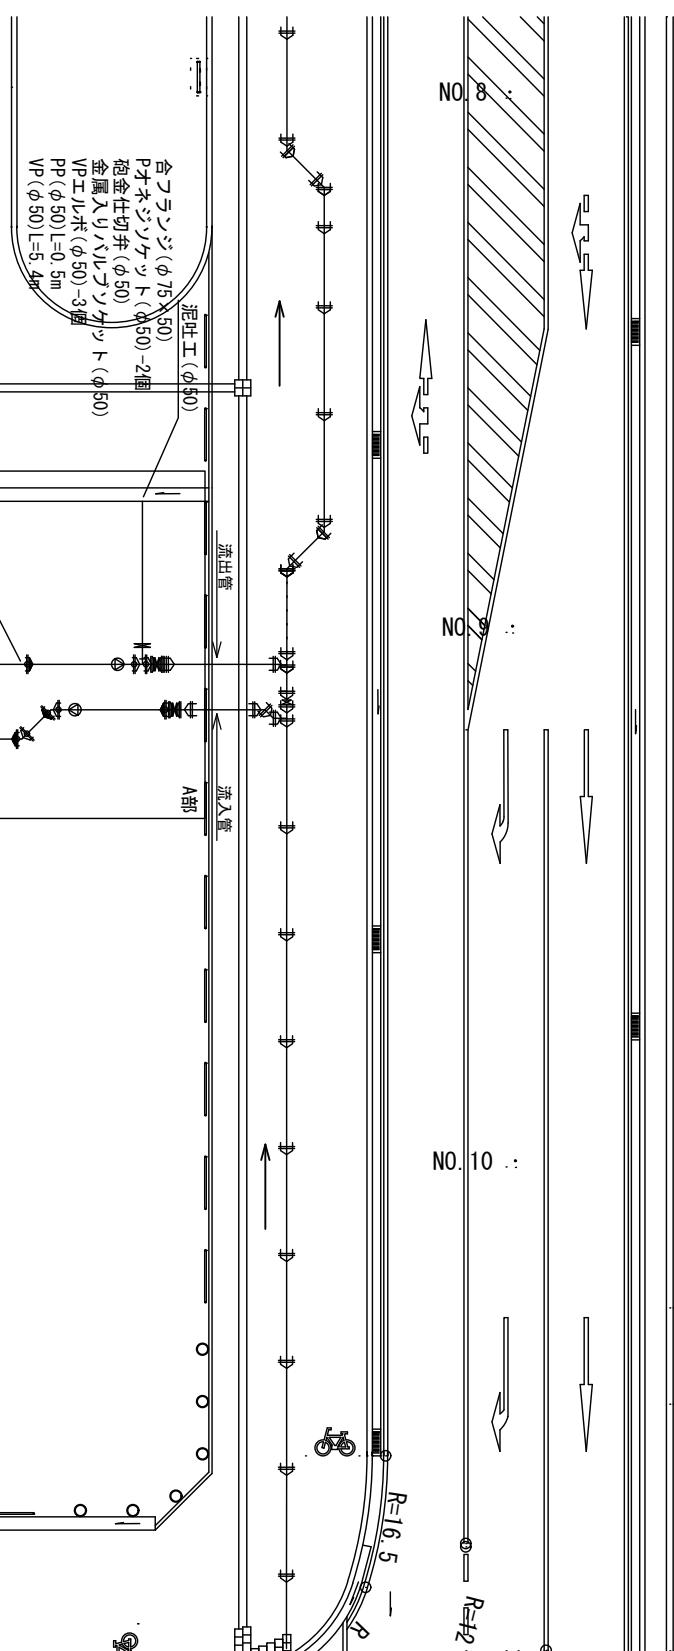

※この図面はA2サイズを原寸とする

工事名 平成31年度工務防災補第1号
施工箇所名 久居駅東口耐震性雨水槽設置工事

占用物件凡例

線種	名称
-----	水道管(新設)
-----	既設水道管
-----	計画下水道管
-----	既設ガス管
-----	既設雨水管
-----	既設NIT

事業所名

津市水道局工務課

